

20/6/2021





Modification Determination

Conflict of Interset

Project No. BGNTX

<u>Connict of Interest</u>	
In this matter:	
 I have declared any possible conflict of interests (re Executive, NSW Land & Housing Corporation. I do not consider I have any personal interests that I will inform the Chief Executive, NSW Land & Hous of a possible conflict of interest. 	would affect my professional judgement.
Signed	
NameDeborah Brill	20/6/2021 Dated

Having regard to the Project Approval Modification Report for this project addressing matters under Part 5 of the *Environmental Planning and Assessment Act 1979,* I approve the proposed modification as outlined in **Schedule 1** and subject to the identified requirements set out in **Schedule 2**.

SCHEDULE 1

Project No. **BGNTX** originally approved on **7 September 2018** and amended **3 August 2020.**

SITE IDENTIFICATION			
STREET ADDRESS			
Unit/Street No	Street or property name		
N/A	Julius Road & Copperfield Drive		
Suburb, town or locality	Postcode		
Rosemeadow	2560		
Local Government Area(s)	Real property description (Lot and DP)		
City of Campbelltown	Lots 90 in DP 1166578 Lots 33 & 34 DP 700703 Part Volume 3714 Folio 16 shown on DP 1148289 Lots 25 & 38 in DP 700703		

^{1.} Conflict of interest includes actual and potential. A conflict of interest includes pecuniary i.e. financial interests to you or a related party or non-pecuniary i.e. benefits to relatives, friends, business associates and personal causes, etc. This includes "related persons" as defined in the Property, Stock and Business Agency Act 2002.

ACTIVITY DESCRIPTION

Provide a description of the activity

Subdivision of four (4) lots into 99 lots, comprising 91 residential lots, three (3) residue lots, one (1) drainage reserve, four (4) future road dedication lots; demolition, associated subdivision works, as well as removal of trees, street landscaping, traffic median infrastructure and installation of additional stormwater quality treatment devices.

Signed.....

Dated.....20/6/2021

Deb Brill Deputy Chief Executive, Head of Policy & Innovation Land & Housing Corporation

SCHEDULE 2 MODIFICATION OF PROJECT APPROVAL

MODIFIED IDENTIFIED REQUIREMENTS

PART A – Standard identified requirements

GENERAL

The following identified requirements have been imposed to ensure that the development activity is carried out in accordance with the plans / documents and any amendments approved under Part 5 of the Environmental Planning & Assessment Act 1979.

1. The development must be carried out substantially in accordance with the following plans / documents as modified below and by any of the undermentioned identified requirements:

Title / Name:	Drawing No / Revision/ Document Ref Issue:		Date	Prepared by:		
Proposed Plan of Subdivision						
Plan of Proposed Subdivision	300178176.03.CC021	D	01/12/20	SMEC		
Subdivision Plans	Subdivision Plans					
Cover Sheet & Locality Plan	300177343.05.DA001	05	17/11/20			
Sheet Schedule & Notes	300177343.05.DA002	05	29/04/21			
Demolition Plan	300177343.05.DA011	04	26/11/20	SMEC		
Services Demolition Plan	300177343.05.DA012	04	14/10/20			
Typical Road Cross Section	300177343.05.DA041	05	14/10/20			

Title / Name:	Drawing No / Document Ref	Revision/ Issue:	Date	Prepared by:
Cut and Fill Plan	300177343.05.DA051	04	14/10/20	
Civil Works Plan	300177343.05.DA101	06	14/10/20	
Road Long Sections	300177343.05.DA201	04	02/10/20	
Section A	300177343.05.DA251	04	14/10/20	
Music Catchment Plan	300177343.05.DA501	03	02/12/20	
Retaining Wall Plan	300177343.05.DA601	05	02/12/20	
Streetscape Plan	300177343.05.DA701	06	03/12/20	
Line Marking and Sign Posting Plan	300177343.05.DA801	04	26/11/20	
Soil and Water Management Plan	300177343.05.DA851	04	26/11/20	
Soil and Water Management Details and Notes	300177343.05.DA861	04	26/11/20	
SPECIALIST REPORTS & CERTIFICA	TES	<u> </u>	1	1
Statement of Compliance - Stormwater Drainage	78176.00.LEO2	-	16/12/20	SMEC
Arboricultural Impact Assessment	2807	-	28/04/2017	Redgum Horticultural
Drainage Report	77343.05	04	19/01/2018	SMEC
Phase 1 and 2 Contamination, Salinity and Geotechnical Investigation	JC17299A-r1	-	August 2017	SMEC
Services Report	77343.05	03	19/01/2018	SMEC
Traffic and Parking Assessment Report	17002	-	15/02/2018	Varga Traffic Planning Pty Ltd

- 2. All subdivision/subdivision works is to be undertaken in accordance with the National Construction Code and referenced Australian Standards.
- 3. All subdivisions works documentation and building work is to be certified in accordance with Section 6.28 of the Environmental Planning and Assessment Act 1979.
- 4. The land subject of this approval must be subdivided as shown in the Plan of Proposed Subdivision. The subdivision plan must be lodged at NSW Land Registry Services and be registered. A copy of the registered plan is to be provided to the Land & Housing Corporation.

OPERATIONAL MATTERS

These identified requirements pertain to the use of the site and have been imposed to ensure that the development and its operation do not interfere with the amenity of the surrounding area.

Stormwater Run-off

- 5. Stormwater is to be collected within the site, and conveyed in a pipeline to the appropriate gutter or drain under the control of the council for the area substantially in accordance with the approved concept stormwater drainage plans.
- 6. Alterations to the natural surface contours or surface absorption characteristics must not impede, increase or divert natural surface water runoff, so as to cause a nuisance to adjoining property owners.

Site Works

- 7. Soil erosion and sediment control measures shall be designed in accordance with the guidelines set-out in the Blue Book *Managing Urban Stormwater: Soils and Construction* (4th edition, Landcom, 2004).
- 8. All soil erosion and sediment control measures required to be put in place prior to the commencement of demolition / subdivision works are to be maintained during the entire period of the works until disturbed areas are restored by turfing, paving or revegetation.
- 9. An appropriately qualified person shall design retaining walls or other methods necessary to prevent the movement of excavated or filled ground, including associated stormwater drainage measures.

Site Soil Contamination

10. The site has been identified as being potentially affected by soil contamination. A proposal for remediation is to be prepared by a suitably qualified person, which may include preparation of a Remedial Action Plan, and remediation is to be carried out in accordance with the proposal. A Validation Report, prepared in accordance with Environment Protection Authority requirements, is to be obtained from a qualified expert on completion of the remediation work to verify that the site is suitable for the intended residential use. A copy of the Validation Report is to be provided to the Land & Housing Corporation on completion of the remediation works.

Landscaping

- 11. A detailed landscape plan showing plant numbers, specie type and size, is to be prepared in consultation with Council and submitted to the Land and Housing Corporation substantially in accordance with the approved Streetscape Plan prior to commencement of subdivision works.
- 12. All scheduled plant stock shall be pre-ordered, prior to commencement of subdivision works or at least 3 months prior to the commencement of landscape construction works, for the supply to the site on time for installation. The builder shall provide a written confirmation of the order to Council and the Land and Housing Corporation.

Public Liability Insurance

13. A valid public liability insurance policy of at least \$10M shall be maintained throughout the demolition / construction works by the contractor or the Land and Housing Corporation (as applicable).

PRIOR TO ANY WORK COMMENCING ON THE SITE

The following identified requirements are to be complied with prior to any work commencing on the site.

Long Service Levy

14. The long service levy shall be paid by the Land & Housing Corporation to the Long Service Payments Corporation in accordance with the Building & Construction Industry Long Service Payments Act 1986 prior to the commencement of any building and construction works.

Note:

Where approval has been granted for development by a Crown body other than a council, the amount payable is 0.35% of the contract inclusive of GST.

(Deleted)

Utilities Service Provider Notification

15. The demolition and subdivision plans must be submitted to the appropriate local / major water utility's office (e.g. Sydney Water office) to determine whether the development will affect the utility's sewer and water mains, stormwater drains and/or easements. If the development complies with water utility's requirements, the plans will be stamped indicating that no further requirements are necessary.

Demolition – General

- 16. Any existing structures, which are not to be retained, are to be demolished prior to commencement of subdivision works associated with the approved development.
- 17. Demolition is to be carried out in accordance with the appropriate provisions of AS 2601 2001.
- 18. Where materials containing asbestos are to be removed, demolition is to be carried out by a licensed contractor(s) who has current SafeWork NSW accreditation in asbestos removal.
- 19. Removal of asbestos-based thermal or acoustic insulation, such as sprayed asbestos and asbestos-based lagging, including friable asbestos boards, shall be carried out in accordance with the National Code of Practice for the Safe Removal of Asbestos [NOHSC:2002 1998)].
- 20. Hazardous or intractable wastes, including all asbestos laden waste, arising from the demolition process shall be removed and disposed of in accordance with the requirements of SafeWork NSW and the Office of Environment and Heritage.
- 21. Documentary evidence in the form of tip receipts from an approved Waste Management Facility shall be obtained by the demolition contractor and submitted to the Land and Housing Corporation demonstrating the appropriate disposal of the asbestos waste.

- 22. Demolition procedures shall maximize the reuse and recycling of demolished materials in order to reduce the environmental impacts of waste disposal.
- 23. During demolition, the public footway and public road shall be kept clear and shall not be obstructed by any demolished material or vehicles. The public road and footway shall be swept (not hosed) clean of any material, including clay, soil and sand.
- 24. All vehicles leaving the site with demolition materials shall have their loads covered and vehicles shall not track soil and other material onto the public roads and footways and the footway shall be suitably protected against damage when plant and vehicles access the site.
- 25. The burning of any demolished material on site is not permitted.

Demolition – Prior to works commencing

- 26. The builder is to notify the occupants of the houses to the east on the opposite side of Copperfield Drive, and to the south and west on the opposite side of Julius Road, a minimum of two days prior to demolition. Such notification is to be clearly written on A4 size paper giving the date demolition will commence and be placed in the letterbox of every premise (including every unit of a multi-unit residential building or mixed use building if applicable). The demolition must not commence prior to the date which has been stated in the notice letter.
- 27. Prior to the demolition, a Work Plan shall be prepared by a competent person(s) in accordance with AS 2601 and shall be submitted to the Land & Housing Corporation. The Work Plan shall outline the identification of any hazardous materials, including surfaces coated with lead paint, method of demolition, the precautions to be employed to minimise any dust nuisance and the disposal methods for hazardous materials.
- 28. On demolition sites where buildings to be demolished contain asbestos cement, a standard commercially manufactured sign containing the words 'DANGER ASBESTOS REMOVAL IN PROGRESS' measuring not less than 400mm x 300mm is to be erected in a prominent visible position on the site.

Note:

Any buildings constructed before 1987 is assumed to contain asbestos.

Stormwater Disposal

- 29. A detailed stormwater drainage plan(s), substantially in accordance with the approved concept stormwater drainage plan(s), is to be prepared and submitted to the Land & Housing Corporation. Any on-site detention system shall be designed in accordance with any catchment authority requirements (e.g. the Upper Parramatta River Catchment Trust On-site Detention Handbook) and/or the council for the area's drainage code.
- 30. Where a drainage easement is required, proof of lodgement of the plan of the drainage easement at the NSW Land Registry Services must be submitted to the Land and Housing Corporation prior to the issue of the Subdivision Certificate.

Council Notification

31. The council for the area shall be advised in writing of the date it is intended to commence work, including demolition. A minimum period of two (2) working days notification shall be given.

Landfill

- 32. Where site filling is necessary, a minimum of 95% standard compacting must be achieved and certified by a NATA registered Soils Lab.
- 33. Land fill materials must satisfy the following requirements:
 - i. be Virgin Excavated Natural Matter (VENM);
 - ii. be free of slag, hazardous, contaminated, putrescible, toxic or radio-active matter; and
 - iii. be free of industrial waste and building debris.

Site Facilities

- 34. The following facilities shall be installed on the site:
 - (a) Toilet facilities shall be provided at the rate of 1 toilet for every 20 persons or part thereof employed at the site. Each toilet provided shall be a standard flushing toilet and shall be connected to a public sewer or if connection to a public sewer is not practicable, to an accredited sewerage management facility provided by the council for the area or if this is not practicable to some other council approved management facility.
 - (b) Adequate refuse disposal methods and builders storage facilities. Builders' wastes, materials or sheds are not to be placed on any property other than that which this approval relates to.
- 35. Access to the site is to be provided only via an all weather driveway on the property and is not to be provided from any other site.

Site Safety

- 36. A sign must be erected in a prominent position on the site on which demolition or subdivision works are being carried out:
 - (a) showing the name, address and telephone number of the responsible Land & Housing Corporation officer for the work, and
 - (b) showing the name of the principal contractor (if any) for any and a telephone number on which that person may be contacted outside working hours, and
 - (c) stating that unauthorised entry to the work site is prohibited.

The sign is to be maintained while the work is being carried out, but must be removed when the work has been completed.

37. A Class A (minimum 1.8m high security fence) or Class B (overhead) hoarding must be erected between the work site and any public place prior to demolition and subdivision works. Access to the site shall be restricted to authorised persons only and the site shall be secured against unauthorised entry when demolition and subdivision work is not in progress or the site is otherwise unoccupied.

Note:

Approval from the relevant roads authority will be required under Section 138 of the Roads Act 1993 where a Class A or B hoarding encroaches onto the footpath of / or a public thoroughfare within a classified road.

38. Prior to commencement of any works, a Traffic Control Plan (TCP) shall be prepared by a suitability qualified person in accordance with the RTA manual *Traffic Control at Work*

Sites and AS 1742.3. A copy of the approved TCP shall be kept on site for the duration of the works in accordance with Work Cover Authority requirements. A copy shall be submitted to the Land and Housing Corporation and to the council for the area for its records.

- 39. All traffic control is to be undertaken and maintained strictly in accordance with AS 1742.3, the requirements set out in the RTA manual *Traffic Control at Work Sites*, all applicable Traffic Management and/or Traffic Control Plans. All Work Cover Authority requirements must also be complied with.
- 40. Demolition waste and/or materials are not to be stored on the council for the area's footpath or roadway.

Protection of Trees

41. Trees and other vegetation that are to be retained on site are to be protected prior to the commencement of works and for the duration of the subdivision works construction period in accordance with the details provided in the submitted arborist report.

Waste Management

42. A final Waste Management Plan is to be prepared and submitted to the Land & Housing Corporation prior to the commencement of demolition and subdivision works. The plan shall detail the amount of waste material and the destination of all materials, recyclable and non-recyclable.

DURING DEMOLITION/ CONSTRUCTION

The following identified requirements are to be complied with whilst works are occurring on the site.

Heritage

- 43. Historic and indigenous archaeological sites and relics are protected under the Heritage Act 1977 and National Parks and Wildlife Act 1974 respectively. Should any relics be uncovered during the course of the approved works, work must cease in the affected area. Subsequently in cases where historical items have been uncovered, the Department of Planning, Industry & Environment must be contacted or if indigenous items have been uncovered the Office of Environment & Heritage must be contacted.
- 44. All workers / contractors must be informed of their obligations under the National Parks and Wildlife Act 1974, namely that it is illegal to disturb, damage or destroy a relic without the prior approval of the Chief Executive of the Office of Environment & Heritage.

Demolition

45. Care shall be taken during demolition to ensure that existing services on the site (ie sewer, electricity, gas, and telecommunications) are not damaged.

Hours of Demolition / Construction / Civil Work

46. Demolition /civil work is only permitted on the site between the hours of 7am to 6pm Monday to Friday and 8am to 1 pm on Saturday with no work permitted on Sundays or public holidays.

Excavation & Backfilling

47. All excavations and backfilling associated with the demolition and subdivision works must be executed safely and in accordance with appropriate professional standards. All such work is to be guarded and protected to prevent it from being dangerous to life or property.

Pollution Control

- 48. Any noise generated during the demolition and subdivision works shall not exceed the limits specified in the July 2009 Interim Construction Noise Guidelines, published by the Department of Environment and Climate Change (now Office of Environment and Heritage).
- 49. No fires are to be lit or waste materials burnt on the site.
- 50. Wastewater from the washing of trucks is not to enter the stormwater drainage system.
- 51. Any contamination / spills on the site during demolition and subdivision works must be actively managed and reported immediately to appropriate regulatory authorities to minimise any potential damage to the environment.
- 52. Dust generation during demolition and subdivision works shall be controlled using regular control measures such as on site watering or damp cloth fences.
- 53. All vehicles transporting loose materials and travelling on public roads must be secured (i.e. closed tail gate and covered) to minimise dust generation.
- 54. Spraying of paint and other materials with the potential to become air borne particulates must only be undertaken in light wind conditions.
- 55. Non-recyclable waste and containers must be regularly collected and disposed of at a licensed landfill or other disposal site in the area in accordance with details set out in the Waste Management Plan to be prepared and submitted to the Land & Housing Corporation prior to the commencement of demolition and subdivision works.

Impact of Construction Works

- 56. The Land & Housing Corporation shall bear the cost of any necessary adjustments to utility mains and services.
- 57. Care shall be taken to prevent any damage to adjoining properties. The building contractor may be liable to pay compensation to any adjoining owner if, due to demolition and subdivision works, damage is caused to such adjoining property.

PRIOR TO ISSUE OF SUBDIVISION CERTIFICATE

The following identified requirements are to be complied with prior to the issue of a subdivision certificate

General

58. The registration of the subdivision shall not occur until all requirements of this approval have been complied with.

Road Damage

59. The cost of repairing any damage caused to the council for the area's assets in the vicinity of the subject site as a result of demolition / subdivision works associated with the approved development is to be met in full by the building contractor.

Stormwater Drainage

- 60. Prior to issuing of the subdivision certificate, a Work As Executed Plan must be prepared clearly showing all aspects of the constructed stormwater drainage system, including any on-site detention system. The plan should demonstrate general compliance with the approved concept stormwater drainage plan(s) and must include:
 - Sufficient levels and dimensions to verify the constructed storage volume.
 - Location and surface levels of all pits.
 - Invert levels of the internal drainage line, orifice plates fitted and levels within the outlet control pit.
 - Finished floor levels of all structures.
 - Verification that any required trash screens have been installed.
 - Locations and levels of any overland flow paths.
 - Verification that any drainage lines are located wholly within easements.

The Work-As-Executed Plan information should be shown on a copy of the final civil works drawings.

A positive covenant and restriction-as-to-user must be placed over any onsite detention system in accordance with the council for the area's on-site detention policy to ensure that system will be adequately maintained. The positive covenant and restriction-as-to-user must be registered at Land and Property Information prior to issue of subdivision certificate. A copy of the registered restriction-as-to-user is to be provided to the Land & Housing Corporation and the council for the area.

SUBDIVISION – PRIOR TO WORKS COMMENCING

The following conditions have been imposed to ensure that the approved subdivision complies with all relevant requirements. These conditions are to be complied with prior to the commencement of any subdivision works on site.

Service Authority Clearances

- 61. [Deleted]
- 62. [Deleted]
- 63. [Deleted]
- 64. [Deleted]

Disconnection of services

65. All previously connected services that are required to be disconnected shall be appropriately disconnected and made safe prior to works commencing. The various service authorities shall be consulted regarding their requirements for the disconnection of services.

66. All existing services within the boundary to remain live must be identified, pegged and made safe.

Existing Drainage

67. Prior to the commencement of subdivision works, a suitably qualified engineer shall certify that the proposed works meet council's engineering standards, and any increased flows from the approved development will have no significant impact on the existing drainage system serving the site, where it is proposed to discharge stormwater.

Alignment of New Works

68. Prior to the commencement of subdivision works, the principal contractor shall liaise with the council for the area and the adjoining land owners regarding the alignment and construction of new roads.

SUBDIVISION – DURING WORKS

The following conditions have been imposed to ensure that the approved subdivision works comply with all relevant requirements. These conditions are to be complied with during the construction of or on completion of subdivision works on site.

Work Zones

69. All loading, unloading and other activities undertaken during demolition and subdivision works shall be accommodated on the development site.

Where it is not practical to load, unload or undertake specific activities on the site during works, the provision of a 'Work Zone' external to the site approval may need to be sought from the council for the area. Where required, the application is to be made prior to the commencement of any works and is to include a suitable traffic/pedestrian management and control plan for the area of the work zone that will be affected.

Footpath Construction

70. The footpath adjoining the subject land shall be regraded in accordance with levels to be obtained from the council for the area, and concrete foot paving is to be constructed in accordance with the approved drawings and the council for the area's specification for subdivision works. Areas not concreted shall be topsoiled and turfed. The footpath formation may need to be extended beyond the site boundary to provide an acceptable transition to existing footpath levels.

Pavement Thickness Determination

71. A road pavement design and pavement thickness report, from a National Association of Testing Authorities, Australia (NATA) registered laboratory, in accordance with the council for the area's specification for subdivision works shall be forwarded to the Land and Housing Corporation a minimum of 2 working days prior to placement of the exposed sub grade.

Inspections – Civil Works

72. The approved civil works shall be inspected at critical stages of construction by the Land and Housing Corporation's Principal Engineer (or delegated officer) in consultation with Council. The inspection schedule is to be determined by the Principal Engineer prior to the commencement of any works and may include the following:

- a. STORMWATER PIPES Laid, jointed and prior to backfill, subsoil drainage lines.
- b. ROAD PAVEMENTS Proof rolling, profile checking, steel inspection.
- c. PIT AND PIPES Inspection prior to backfill of pipes, steel inspection of pits, final inspections of pits.
- d. VEHICLE CROSSINGS AND LAYBACKS Prior to pouring concrete.
- e. FINAL INSPECTION All outstanding work.

SUBDIVISION – PRIOR TO ISSUE OF SUBDIVISION CERTIFICATE

The following conditions must be complied with prior to the issue of a subdivision certificate by LAHC.

Service Authority Certification

- 73. A compliance certificate is to be obtained from the relevant local / major water utility (eg the local council for the area or Hunter Water or Sydney Water) or other evidence confirming service connection is to be obtained and submitted to the Land and Housing Corporation prior to issue of the subdivision certificate.
- 74. A copy of the written clearance obtained from the electricity supply authority stating that electrical services have been made available to the development or that arrangements have been entered into for the provision of services to the development is to be submitted to the Land and Housing Corporation prior to issue of the subdivision certificate.
- 75. A copy of the certificate from an approved telecommunications carrier to certify that satisfactory arrangements have been made to ensure the provision of telephone services to each newly created lot is to be submitted to the Land and Housing Corporation prior to issue of the subdivision certificate.
- 76. Where the site is to be connected to reticulated gas, a copy of the certificate from an approved gas carrier to certify that satisfactory arrangements have been made to ensure the provision of underground gas services to each newly created lot in the development is to be submitted to the Land and Housing Corporation prior to issue of the subdivision certificate.

Civil Construction Certification

77. Prior to issuing a subdivision certificate an appropriately delegated person within the Land and Housing Corporations is to certify that all civil works, including driveways, crossovers and common drainage lines have been constructed in accordance with the certified civil drawings.

Residential Interallotment Drainage

78. Prior to issuing a subdivision certificate, verification shall be submitted to the Land and Housing Corporation demonstrating that interallotment drainage and associated easements have been provided for residential lots where all or part of the lots do not drain to a public road.

Works As Executed Plan

79. Prior issuing a subdivision certificate, the following documents shall be submitted to the Land and Housing Corporation:

- a. Two (2) complete sets of fully marked up and certified work as executed plans in accordance with the approved plans and specifications for subdivision and drainage works and two (2) copies of the line marking/ signposting plan(s).
- b. Two (2) copies of any lot classification reports, geotechnical stability reports, dispersion tests, earthworks and fill placement reports, concrete core tests, sub grade and pavement density reports, structural and all other testing undertaken.
- c. Two (2) copies of any compliance certificates, including supply of pipes and precast units, supply of sub-base material, supply of base course material, supply of concrete, and supply of bituminous materials.

All reports/ certificates shall be prepared by a NATA registered laboratory or qualified engineer and shall list the relevant compliance standard/s and certify that the whole of the area of works or materials tested comply with the relevant specification. All reports/ certificates shall be complete, fully referenced, clearly indicate the area or material tested, the location and required/ actual values of all tests and retesting, and be collated and suitably bound.

Endorsement of Linen Plan

80. Two originals plus five (5) copies of the Plan of Subdivision creating the new allotments and the original 88B instrument, if applicable, shall be submitted to the Land and Housing Corporation for endorsement prior to lodgement at the NSW Land Registry Services.

The plan of subdivision must be prepared by a surveyor and must include the details of the easements to be applied to the site and the dedication of assets to Council.

Restriction on the Use of Land

- 81. Prior to issuing a subdivision certificate, appropriate restrictions on the use of land under Section 88B of the Conveyancing Act are to be applied, such as:
 - a. Common Drainage Lines
 - b. Overland flow paths
 - c. Party wall easements

Restrictions/ easements may also include the following:

- a. Floor Level Control
- b. No Alteration To Surface Levels
- c. Lots filled
- d. Access denied
- e. Set back from access denied roads
- f. Uncontrolled fill
- g. Finished floor levels
- h. No cut or fill
- i. Reciprocal rights of carriageway
- j. Lots with any other restrictions

The council for the area shall be consulted regarding required wording, where applicable. Any lots subsequently identified during the subdivision process as requiring restrictions shall also be suitably burdened. Where applicable, the authority empowered to release, vary or modify these restrictions on the use of land shall be the council for the area.

PART B – Additional identified requirements

Site/project specific conditions

82. Each lot created by the subdivision is to have an individual service connection to the mains for sewer and water which does not traverse another lot.

Any required meters must be located wholly within the relevant lot boundaries.

82A. Lot 194 must be developed wholly for the purpose of Seniors housing, as defined in SEPP (Housing for Seniors or People with a Disability) 2004.

Conditions resulting from consideration of Campbelltown City Council's comments

- 83. At the intersection between Road 1 and Malcolm Way at Copperfield Drive, new splitter islands/median strips (e.g. of approximately 200mm width) are to be submitted to council prior to commencement of subdivision works and constructed as part of stage 3.
- 84. Detailed drainage design including connection details and levels are to be submitted to council prior to commencement of subdivision works.
- 85. [Deleted]
- 86. An easement shall be provided along the width of the retaining wall footing, requiring the owner of the lot to allow access for maintenance and preventing the owner of the lot from amending the adjoining levels without structural advice.
- 87. Laybacks are to be incorporated within construction documentation for driveways on Copperfield Drive prior to commencement of subdivision works and are to be constructed as part of Stage 3.
- 88. Kerb outlets are to be identified on Construction plans, including detail or note to include pipework to the boundary prior to commencement of subdivision works and constructed as part of Stage 3.
- 89. A suitable section 88B restriction is to be created in favour of Campbelltown City Council within Lot 38 DP 700703 for access to, and maintenance of, stormwater infrastructure prior to issue of the Subdivision Certificate.
- 90. Suitable concrete access and turning head infrastructure is to be provided within construction documentation for Lot 195 and existing Lot 38 DP 700703 prior to commencement of subdivision works and constructed as part of Stage 3.

Conditions as requested by public authorities other than councils

91. Nil conditions

<u>Note</u>

These are additional conditions of consent requested by public authorities consulted under Clause 16 of State Environmental Planning Policy (Infrastructure) 2007, which is saved under ARH SEPP.

Conditions resulting from consideration of adjoining occupier comments

92. Nil conditions

Specific service/ utility agency conditions

93. Nil conditions

ADVISORY NOTES

- i. Approval of this development activity does not imply or infer compliance with Section 23 of the Disability Discrimination Act 1992. Refer to AS 1428.1 and the Building Code of Australia for detailed guidance.
- ii. Information regarding the location of underground services may be obtained from Dial Before You Dig at *www.1100.com.au* or by dialling 1100.

Standard advisory notes

Disability Discrimination Act

i. Approval of this development activity does not imply or infer compliance with Section 23 of the Disability Discrimination Act 1992. Refer to AS 1428.1 and the Building Code of Australia for detailed guidance.

Dial 1100 Before You Dig

ii. Information regarding the location of underground services may be obtained from Dial Before You Dig at *www.1100.com.au* or by dialling 1100.

Inspection within Public Areas

iii. The council for the area should be consulted regarding all works within public areas, which may be required to be inspected at critical stages of construction and by the council on completion.

Inspections – Civil Works


iv. The council for the area should be contacted before each critical stage inspection of the approved civil works on the site is carried out to arrange joint inspections of the works together with Housing NSW to facilitate the handover of public infrastructure assets on completion of the works.

Additional advisory notes resulting from consideration of the council for the area's comments

v. Nil advisory notes / Insert as necessary


<u>Note</u>

These additional advisory notes deal with matters advised by the council for the area that are not covered in the standard advisory notes but are considered appropriate for inclusion.

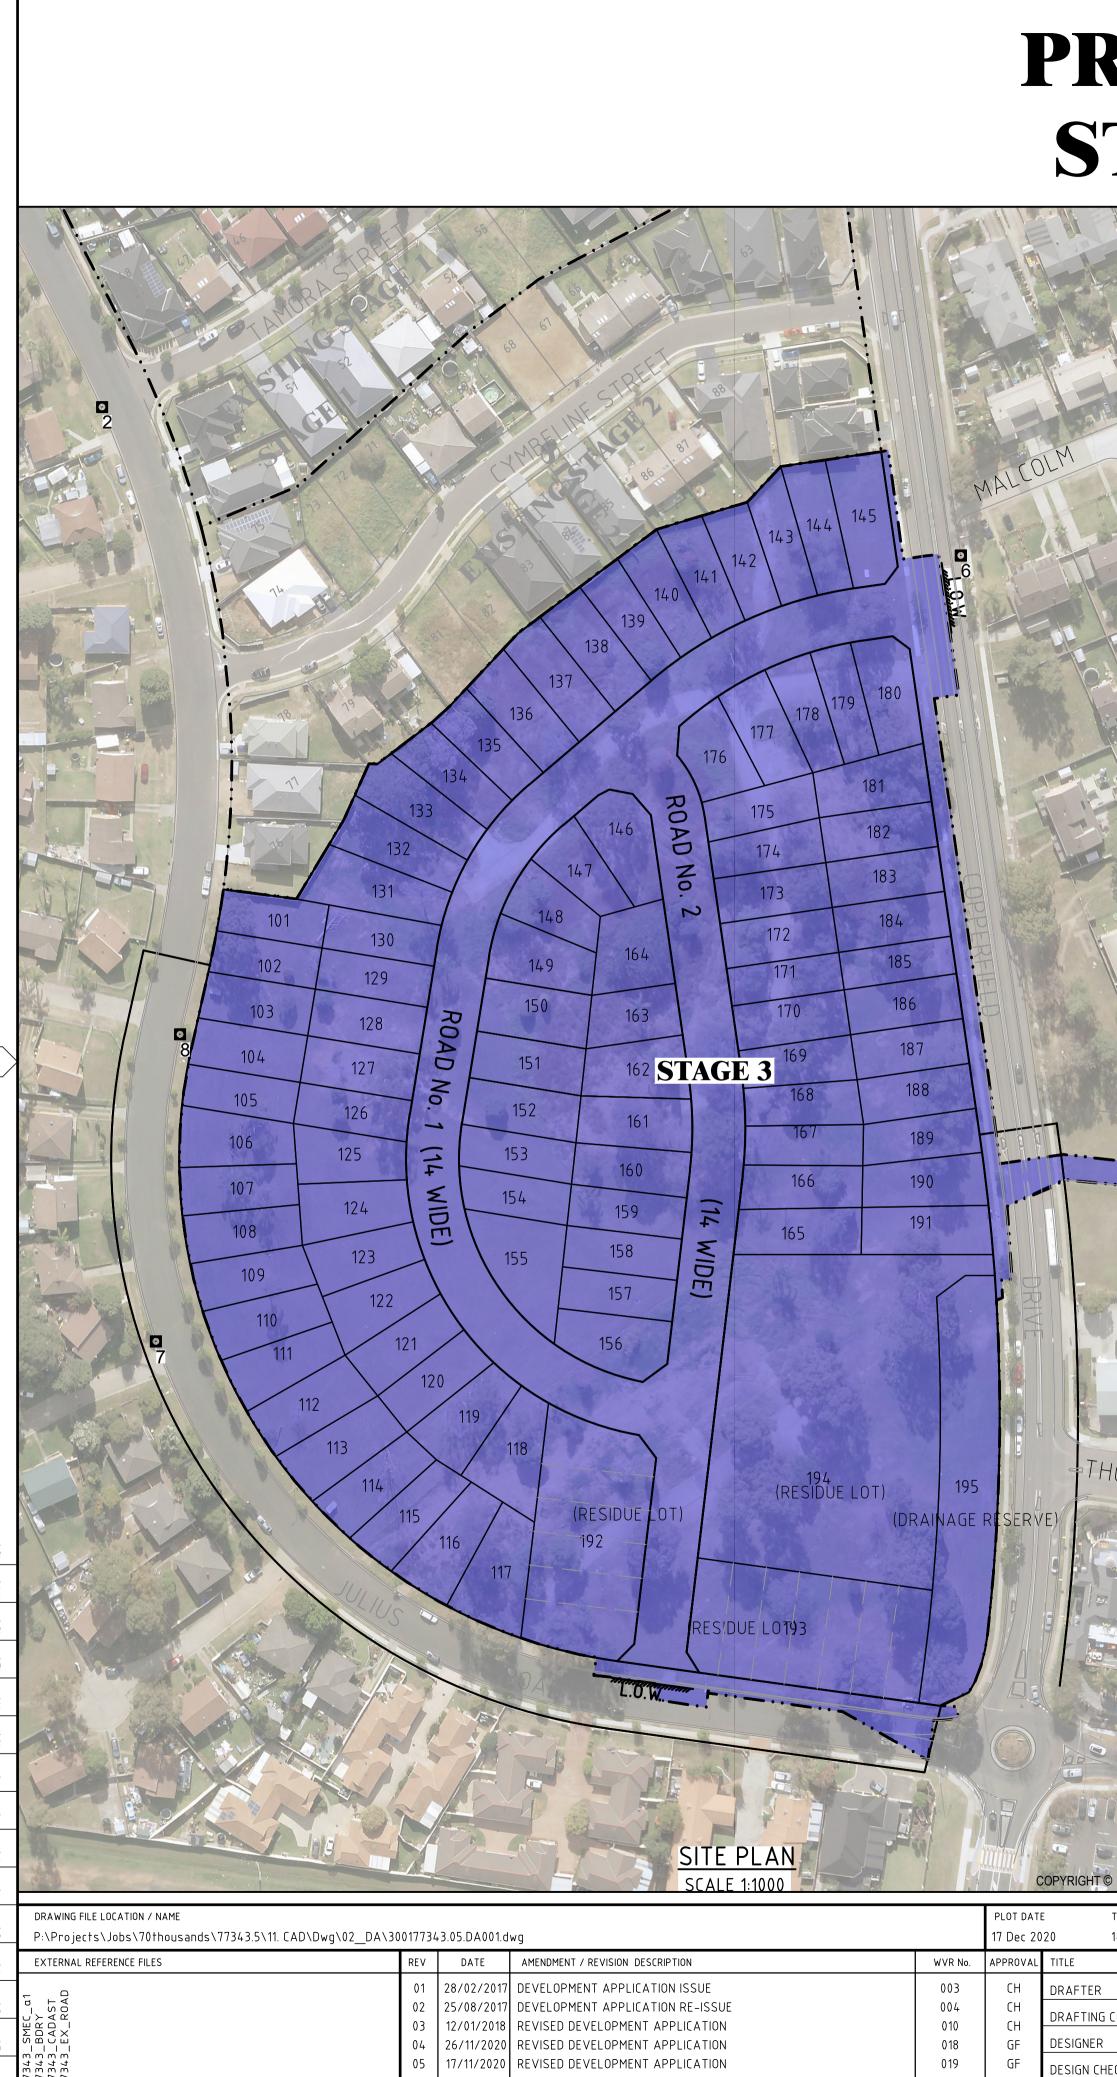

PROPOSED SUBDIVISION STAGE 3 ROSEMEADOW



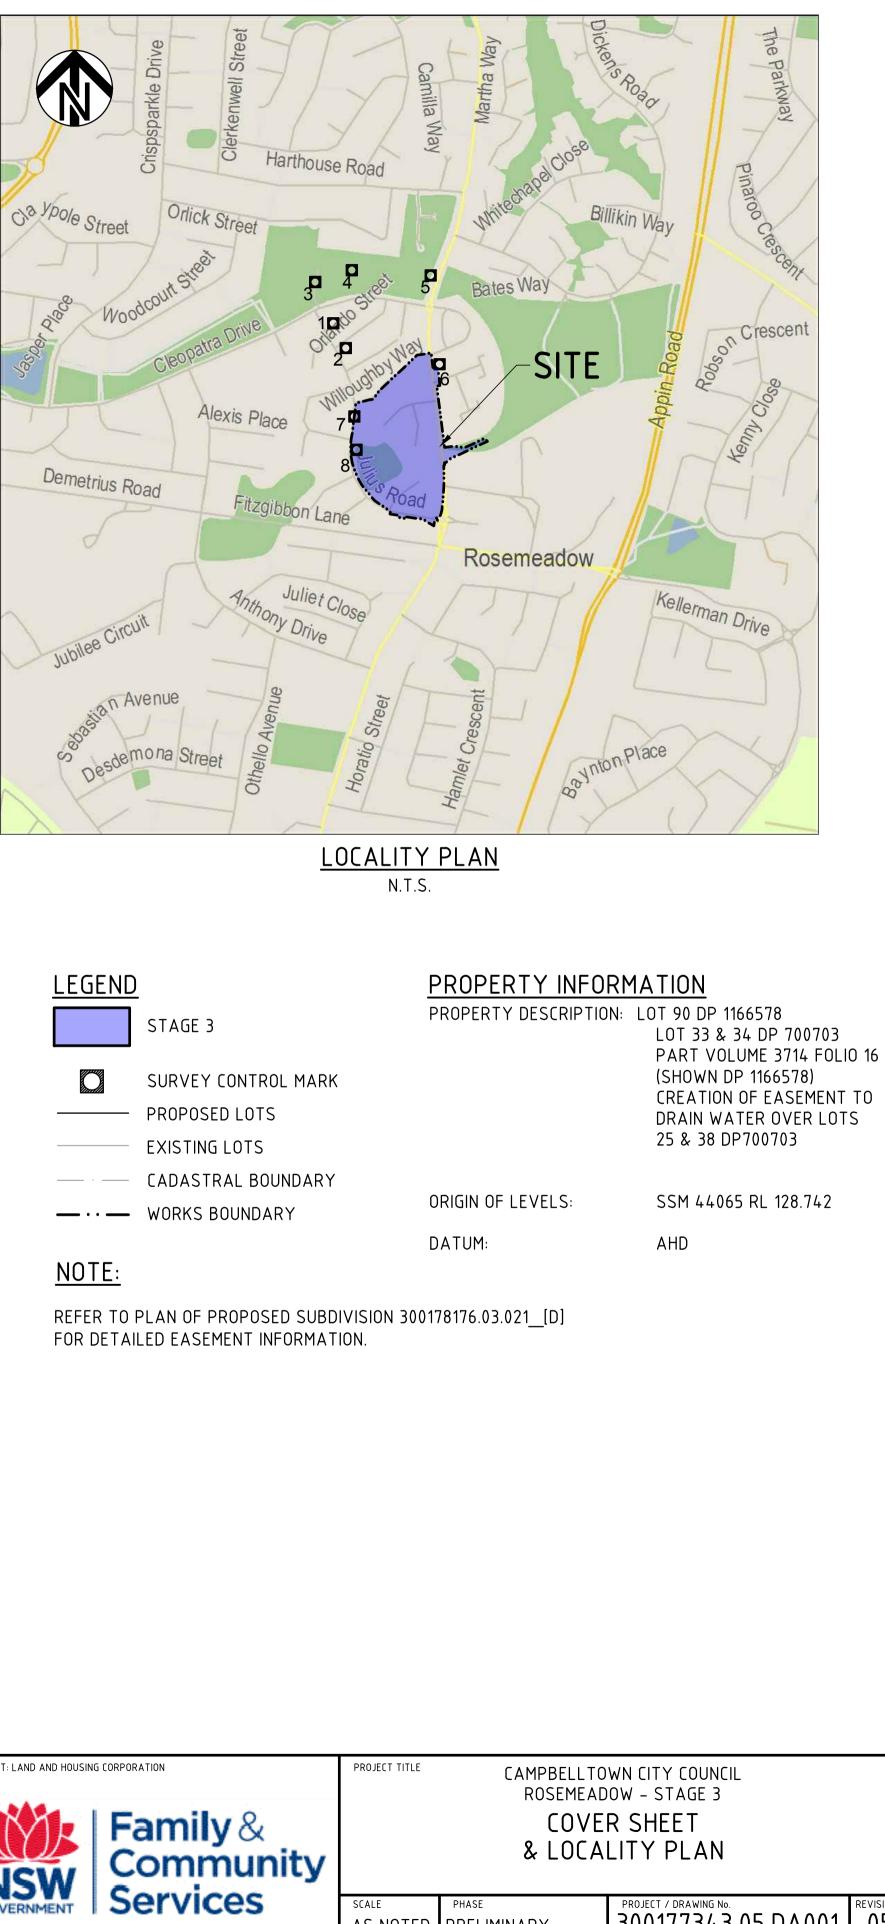

SCALE

PHASE

AS NOTED PRELIMINARY

LOT DESCRIPTION

LOT No.	PROPOSED DEVELOPMENT	
101–191	RESIDENTIAL LOT	
192 & 193	RESIDUE LOT	
194	SENIOR LIVING DEVELOPMENT	
195	DRAINAGE RESERVE	
196 & 197	7 FUTURE ROAD DEDICATION LOTS	

SURVEY CONTROL

POINT No.	EASTING	NORTHING	REDUCED LEVEL	REMARKS	
1	296587.33	6224881.55	134.015	SSM 168947	
2	296617.597	6224821.498	137.034	SSM 168948	
3	296543.301	6224981.38	129.19	SSM 39466	
4	296632.342	6225010.246		SSM 39465	
5	296823.293	6224997.48	128.870	SSM 39464	
6	296844.779	6224782.226	128.742	SSM 44065	
7	296631.843	6224574.372		SSM 39469	
8	296638.23	6224655.583		SSM 39468	
NOTE: CO-ORDINATES ARE MGA (GROUND) SUPPLIED BY LAHC					

<u>LEGEND</u>	
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THOMAS ROSE DRIVE	
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DRAFTER		NAME Z. KHALIL	SCALES AT A1 SIZE DRAWING	DESIGNER	CLIENT: LAND AND HOUSING CORPORATION
DRAFTER DRAFTING CH		G. FLEMING			- Ear
DESIGNER		L. RYAN		Member of the Surbana Jurong Group ⓒ ABN 47 065 475 149	Con
DESIGN CHEC PROJECT MAI		<u>G. FLEMING</u> G. FLEMING	10 0 10 20 30 40 50 SCALE 1:1000	LEVEL 6, 3 HORWOOD PLACE PARRAMATTA NSW. 2150 PH +61 2 9900 7100	SOVERNMENT Serv
PROJECT DIR	ECTOR	C. MILES		SMEC PROJECT No. 300177343.5	GOVERNMENT F COT

DETERMINED by the New South Wales Land & Housing Corporation on:



PROJECT / DRAWING No. REVISION 300177343.05.DA001 05

20/6/2021

SHEET SCHEDULE			лотц
DRAWING	DESCRIPTION		<u>ARTH</u>
300177343.05.DA001	COVER SHEET & LOCALITY PLAN	1.	EART
300177343.05.DA002	SHEET SCHEDULE & NOTES		REMO
300177343.05.DA011	DEMOLITION PLAN		COMP
300177343.05.DA012	SERVICES DEMOLITION PLAN	2.	COMP ROAD
300177343.05.DA041	TYPICAL ROAD CROSS SECTION		THE C
300177343.05.DA051	CUT AND FILL PLAN		EART
300177343.05.DA101	CIVIL WORKS PLAN		ASI28
300177343.05.DA201	ROAD LONG SECTIONS		RESU
300177343.05.DA251	SECTION A	3.	THE S
300177343.05.DA501	MUSIC CATCHMENT PLAN		DEFIN
300177343.05.DA601	RETAINING WALL PLAN		AND / SPECI
300177343.05.DA651	STRUCTURAL DETAILS	4.	IN AR
300177343.05.DA701	STREETSCAPE PLAN		PREV
300177343.05.DA801	LINE MARKING AND SIGN POSTING PLAN	5.	ALL E
300177343.05.DA851	SOIL AND WATER MANAGEMENT PLAN	6.	PROV
300177343.05.DA861	SOIL AND WATER MANAGEMENT DETAILS AND NOTES		DISTL
TOTAL SHEET NUMBER OF	16		14 D A
SHEETS	18	7.	THEC
			WITH
٨	SSOCIATED REFERENCE DRAWINGS:	8.	PROD A MIN
<u>A.</u>	SOCIATED NEI ENENCE DIVA WINDS.	0.	

DESCRIPTION

PLAN OF PROPOSED SUBDIVISON

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GENERAL	NOT	TES:

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DRAWING

300178176.03.0021

<u>GE</u>	<u>INERAL NOTES:</u>		A P
1.	ALL WORK TO BE CARRIED OUT IN ACCORDANCE WITH CAMPBELLTOWN COUNCIL'S SPECIFICATIONS AND TO THE REQUIREMENTS OF COUNCIL'S ENGINEER.		, T IN
2.	INSPECTIONS BY THE CAMPBELLTOWN COUNCIL'S ENGINEER SHALL BE CARRIED OUT AT THE FOLLOWING STAGES: 2.1. PRIOR TO INSTALLATION OF EROSION AND SEDIMENT CONTROL STRUCTURES 2.2. PRIOR TO BACKFILLING PIPELINES, SUBSOIL DRAINS AND DAMS	3. 4.	S P P
	2.3. PRIOR TO CASTING OF PITS AND OTHER CONCRETE STRUCTURES, INCLUDING KERB AND GUTTER BUT FOLLOWING PLACEMENT OF FOOTINGS, FORMWORK AND REINFORCEMENT	5.	D A
	2.4. PRIOR TO PLACEMENT OF SUB BASE AND ALL SUBSEQUENT PAVEMENT LAYERS, A PROOF ROLLER TEST OF EACH PAVEMENT LAYER IS REQUIRED		C H
	2.5. FORMWORKS PRIOR TO POURING CONCRETE IN PARKING AREA FOR FOOTPATH CROSSING AND OTHER ASSOCIATED WORK.	6.	A C C
	 2.6. PRIOR TO BACKFILLING PUBLIC UTILITY CROSSINGS IN ROAD RESERVES 2.7. FINAL INSPECTION AFTER ALL WORKS ARE COMPLETED AND 'WORK AS EXECUTED' PLANS HAVE BEEN SUBMITTED TO COUNCIL 		P EI
3. 4.	NO TREES TO BE REMOVED UNLESS APPROVAL IS GRANTED BY COUNCIL'S LANDSCAPE COMPLIANCE OFFICER. MAKE SMOOTH JUNCTIONS WITH EXISTING WORKS.		А
5.	NO WORK TO BE CARRIED OUT ON COUNCIL PROPERTY OR ADJOINING PROPERTIES WITHOUT THE WRITTEN PERMISSION FROM THE OWNER/S.	<u>R0</u>	<u> </u>
6.	VEHICULAR ACCESS AND ALL SERVICES TO BE MAINTAINED AT ALL TIMES TO ADJOINING PROPERTIES AFFECTED BY CONSTRUCTION.	1. 2.	S S
7. 8.	ALL RUBBISH, BUILDINGS, SHEDS AND FENCES TO BE REMOVED TO SATISFACTION OF COUNCIL'S ENGINEER. THE CONTRACTOR SHALL OBTAIN ALL LEVELS FROM ESTABLISHED BENCH MARKS ONLY.	3.	1 <u>5</u> S
9.	PERMANENT SURVEY CO-ORDINATION MARKS MUST BE PLACED WITHIN THE SUBDIVISION IN ACCORDANCE WITH THE SURVEYORS ACT AND REGULATIONS.	4. 5.	L
10. 11.	PLACE AND LEVEL NEW S.S.M.'S TO LPI'S REQUIREMENT IN POSITION AS DIRECTED BY THE CONSULTING SURVEYOR. ANY DISCREPENCY TO BE REPORTED TO THE SUPERINTENDENT IMMEDIATELY SO THAT FURTHER INFORMATION MAY BE	б.	N P
12.	OBTAINED FROM SMEC. THE SITE MUST BE ENCLOSED WITH A SUITABLE TEMPORARY 'A' CLASS TYPE HOARDING OR SECURITY FENCE OF A TYPE APPROVED BY THE CONSENT AUTHORITY. SUCH HOARDING MUST NOT ENCROACH UPON THE ROAD RESERVE OR	7.	т М С
	OTHER PRIVATE LAND WITHOUT THE WRITTEN CONCURRENCE OF THE AFFECTED PROPERTY OWNER. IF IT IS PROPOSED TO LOCATE SUCH A HOARDING WITHIN ANY PROPERTY OWNED/CONTROLLED BY CAMPBELLTOWN COUNCIL, A PUBLIC ROAD ACTIVITY APPLICATION MUST BE SUBMITTED TO AND APPROVED BY COUNCIL, PRIOR TO THE HOARDING BEING	8. 9.	S A A
13.	THAT APPROVED BY THIS DEVELOPMENT CONSENT WILL NOT BE PERMITTED WITHOUT THE PRIOR CONSENT OF	10.	
14.	CAMPBELLTOWN COUNCIL. PRIOR TO THE COMMENCEMENT OF ANY WORK WITHIN THE SITE A SIGN (MINIMUM SIZE OF 300mm X 400mm) MUST BE INSTALLED WITHIN THE SITE ADVISING OF THE FOLLOWING:		R R O
	 14.1. FULL DETAILS OF THE PCA 14.2. FULL DETAILS OF THE CONSTRUCTION CERTIFICATE 14.3. FULL DETAILS OF DEVELOPMENT CONSENT, AND 	11. 12.	
	14.4. FULL DETAILS OF THE BUILDER/CONTRACTOR THE SIGN MUST BE LOCATED WITHIN THE SITE AND CLEARLY VISIBLE AND LEGIBLE FROM THE ROAD FOOTWAY AND MUST BE DISPLAYED FOR THE DURATION OF THE	· <u> </u>	

ISIDLE AND LEGIDLE FROM THE ROAD FOUTWAT, AND MUST DE DISPLATED FOR THE DORATION OF THE CONSTRUCTION WORKS.

15. ALL LEVELS ARE TO AUSTRALIAN HEIGHT DATUM

50	DRAWING FILE LOCATION / NAME X:\Projects\300177\300177343.5\11. CAD\Dwg\02_DA\300177343.05.DA002.dwg									
4 0	EXTERNAL REFERENCE FILES	REV	DATE	AMENDMENT / REVISION DESCRIPTION	WVR No.	APPROVAL	TITLE			
7	_	01	28/02/2017	DEVELOPMENT APPLICATION ISSUE	003	СН	DRAFTER			
30	Ŭ I	02	25/08/2017	DEVELOPMENT APPLICATION RE-ISSUE	004	СН	DRAFTING CH			
	Ξ U	03	12/01/2018	REVISED DEVELOPMENT APPLICATION	010	СН				
20		04	26/11/2020	REVISED DEVELOPMENT APPLICATION	018	GF	DESIGNER			
	7343	05	29/04/2021	REVISED DEVELOPMENT APPLICATION	020	GF	DESIGN CHECK			
10	30017						PROJECT MAN			
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WORKS NOTES:

THWORKS ARE TO BE CARRIED OUT TO THE SATISFACTION OF THE COUNCIL. UNSUITABLE MATERIALS ARE TO BE 10 YED FROM ROADS AND LOTS PRIOR TO FILLING. THE CONTRACTOR IS TO ARRANGE AND MAKE AVAILABLE 1PACTION TESTING RESULTS FOR ALL AREAS THAT CONTAIN FILL IN EXCESS OF 200mm

MPACTION OF EARTHWORKS SHALL CONTINUE UNTIL A DRY DENSITY RATIO OF 95% FOR SITE FILLING AND 100% FOR AD PAVEMENT SUBGRADES HAS BEEN ACHIEVED IN ACCORDANCE WITH TEST METHOD AS1289.5.3.1 OR AS1289.5.1.1. CONTROL TESTING OF EARTHWORKS SHALL BE IN ACCORDANCE WITH THE GUIDELINES IN AS3798 'GUIDELINES ON THWORKS FOR COMMERCIAL AND RESIDENTIAL DEVELOPMENTS'. WHERE IT IS PROPOSED TO USE TEST METHOD 289.5.8.1 TO DETERMINE THE FIELD DENSITY, A SAND REPLACEMENT METHOD SHALL BE USED TO CONFIRM THE SULTS.

SUITABLE QUALIFIED GEOTECHNICAL ENGINEER. SHALL HAVE A LEVEL 1 RESPONSIBILITY FOR ALL FILLING AS INED IN APPENDIX B AS3798 GUIDELINES ON EARTHWORKS FOR COMMERCIAL AND RESIDENTIAL DEVELOPMENTS',) AT THE END OF THE WORKS SHALL CONFIRM THE EARTHWORKS COMPLY WITH THE REQUIREMENTS OF THE ECIFICATION AND DRAWINGS BY WRITTEN NOTIFICATION.

AREAS TO BE FILLED WHERE THE SLOPE OF THE NATURAL SURFACE EXCEEDS 1(V):4(H), BENCHES ARE TO BE CUT TO EVENT SLIPPING OF THE PLACED FILL MATERIAL AS REQUIRED BY THE COUNCIL.

BATTERS ARE TO BE SCARIFIED TO A DEPTH OF 50mm TO ASSIST WITH ADHESION OF TOP SOIL TO BATTER FACE. VIDE MINIMUM 150mm AND MAXIMUM 300mm TOPSOIL ON FOOTPATHS, FILLED AREAS AND ALL OTHER AREAS FURBED DURING CONSTRUCTION. TOPSOILED AREAS TO BE STABILISED WITH APPROVED VEGETATION A MAXIMUM OF DAYS AFTER TOPSOILING AND ARE TO BE WATERED TO ENSURE GERMINATION.

CONTRACTOR SHALL CONTROL SEDIMENTATION, EROSION AND POLLUTION DURING CONSTRUCTION IN ACCORDANCE "H THE REQUIREMENTS OF THE CURRENT EDITION OF MANAGING URBAN STORMWATER: SOILS AND CONSTRUCTION" ODUCED BY LANDCOM.

A MINIMUM 1 METRE WIDE, CONTINUOUS STRIP OF COUCH GRASS SHALL BE PLACED BEHIND THE BACK OF ALL KERBS AND OTHER CONCRETE STRUCTURES IMMEDIATELY AFTER THE COMPLETION OF THE FOOTPATH GRADING OR OTHER ELEMENTS AS APPLICABLE, AND SHALL BE MAINTAINED AND REPLACED AS REQUIRED DURING THE CONSTRUCTION MAINTENANCE PERIOD AND MAINTENANCE PERIODS.

SERVICES NOTES

1. SERVICE CONDUITS TO BE PLACED AS DIRECTED BY ENDEAVOUR, NBN CO. AND AS REQUIRED BY SYDNEY WATER CORPORATION.

2. EXISTING UNDERGROUND SERVICES SHOWN AS PART OF THIS DRAWING SET HAVE BEEN DIGITALLY PROVIDED OR DIGITISED FROM SURVEY AND DBYD INFORMATION. THIS INFORMATION HAS BEEN SHOWN ONLY TO PROVIDE APPROXIMATE LOCATION OF SERVICES AT THE TIME OF PREPERATION OF THIS DRAWING SET. SERVICES SHALL NOT BE ASSUMED TO BE AS CONSTRUCTED OR ACCURATE. SMEC DOES NOT GUARANTEE OR ACCEPT ANY LIABILITY FOR THEIR PRESENCE OR ABSENCE. IT IS THE CONTRACTORS RESPONSIBILITY TO UNDERTAKE DBYD SEARCHES AND ESTABLISH THE LOCATION AND LEVEL OF ALL EXISTING SERVICES PRIOR TO COMMENCEMENT OF WORKS. ANY VARIATION TO THE NFORMATION ON THIS DRAWING SET IS TO BE REPORTED TO THE SUPERINTENDENT AND SMEC IMMEDIATELY. ALL SEARCH RESULTS TO BE AVAILABLE ON SITE AT ALL TIMES.

PUBLIC UTILITY SERVICES ARE TO BE ADJUSTED AS NECESSARY.

PROPOSED SERVICE CROSSING TO BE THRUST BORED UNDER EXISTING ROAD PAVEMENT. CONTRACTOR TO REPAIR ANY DAMAGE TO EXISTING SURFACE

ALL SYDNEY WATER HYDRANTS ARE TO BE CLEARLY IDENTIFIABLE BY APPROPRIATE KERB MARKINGS AND BLUE COLOURED RAISED REFLECTIVE PAVEMENT MARKERS PLACED AT THE CENTRELINE OF THE ROAD OPPOSITE THE YDRANT. THESE PAVEMENT MARKERS ARE TO BE REINSTATED AFTER PLACEMENT OF THE FINAL LAYER OF SPHALTIC CONCRETE AND PRIOR TO THE RELEASE OF THE ROAD SURFACING BOND

ONTRACTOR TO INSTALL ELECTRICAL, NBN AND GAS DUCT CROSSINGS TO RELEVANT AUTHORITY STANDARDS. ONTRACTOR TO SURVEY & CERTIFY COVER TO EACH ROAD DUCT CROSSING AS GIVEN ON THE APPROVED ELECTRICAL PLAN. LEVELS & CERTIFICATION TO BE PROVIDED TO SMEC FOR CONFIRMATION AND SUBMISSION OF W.A.E. LEVELS TO NDEAVOUR ENERGY FOR CERTIFICATION. ALTERNATIVELY, CONTACT SMEC ONE DAY PRIOR TO TRENCH BEING OPEN AND/OR BACKFILLED FOR CERTIFICATION.

DWORKS NOTES:

SUBGRADES AND SUB BASES ARE TO BE COMPACTED IN ACCORDANCE WITH COUNCIL'S CONSTRUCTION SPECIFICATION SUBSOIL DRAINS TO BE PROVIDED ON BOTH SIDES OF ROADS (EXCEPT WHERE THERE IS STORMWATER DRAINAGE). 50 x 50 H.D. GALVANISED STEEL KERB OUTLETS TO BE PLACED IN ALL KERB TYPES ON LOW SIDE OF LOTS. PROVIDE SUITABLE ADAPTOR TO ALL.O.W. CONNECTION OF 90mm DIAMETER STORMWATER PIPE.

IPLESS PERAMBULATOR CROSSINGS ARE TO BE PROVIDED IN ALL KERB RETURNS AND WHERE REQUIRED BY COUNCIL SERVICE CONDUITS TO BE PLACED AS DIRECTED BY ALL PUBLIC UTILITY AUTHORITIES INCLUDING ENDEAVOUR ENERGY, NBN CO. AND SYDNEY WATER

PROPOSED UTILITIES AND SERVICES CROSSING EXISTING ROADS SHALL BE PROVIDED FOR USING A TRENCHLESS TECHNIQUE SO AS NOT TO DAMAGE THE EXISTING SURFACE. ALL SERVICE CONDUITS UNDER ROADS MUST BE LAID TO A 1INIMUM DEPTH OF 750mm.

CONCRETE FOOTPATH CONSTRUCTION IS TO BE BONDED WITH COUNCIL PENDING COMPLETION OF UTILITY/SERVICES AND SURROUNDING DWELLINGS.

ALL TEMPORARY ROADS MUST BE TEMPORARILY SEALED WITH A SINGLE COAT FLUSH SEAL.

ALL PERMANENT ROADS MUST BE SEALED WITH A SINGLE COAT FLUSH SEAL AND 50mm OF AC TO BE APPLIED IN TWO 5mm THICK LAYERS. THE FINAL AC LAYER IS TO BE AC 10 AND IS TO BE BONDED AND PLACED FOLLOWING APPROVAL ROM COUNCIL

SIGNPOSTING AND LINE MARKING SHALL CONFORM TO AS1742.2 'TRAFFIC CONTROL DEVICES FOR GENERAL USE'. RAISED RETRO-REFLECTIVE PAVEMENT MARKERS TO CONFORM TO AS1 906 'RETRO-REFLECTIVE MATERIALS AND DEVICES FOR ROAD TRAFFIC CONTROL PURPOSES'. ALL APRONS AND KERB FACE ON CENTRAL ISLANDS OF ROUNDABOUTS AND ALL THER ISLANDS TO BE DELINEATED BY REFLECTIVE WHITE MARKING. INSTALLATION SHALL OCCUR IN ACCORDANCE WITH THE PLAN APPROVED BY THE LOCAL TRAFFIC COMMITTEE.

ALL LOT AND HOUSE NUMBERS MUST BE STENCILED ON KERB FACE.

STREET SIGNS TO COUNCIL STANDARD MUST BE INSTALLED BY THE CONTRACTOR.

STORMWATER NOTES:

- THE COUNCIL ENGINEER
- UNLESS OTHERWISE APPROVED BY THE COUNCIL ENGINEER.

- ACCORDANCE WITH COUNCIL'S REQUIREMENTS.
- AUTHORITY

GEOTECHNICAL NOTES:

- COUNCIL'S DIRECTION.
- ACCORDANCE WITH A.S.A. 1289 TESTS 12 AND 13.

- REPORT TO COUNCIL.

DETERMINED by the New South Wales Land & Housing Corporation on:

TIME 08:25:03				
	NAME	SCALES AT A1 SIZE DRAWING	DESIGNER	CLIENT: LAND AND HOUSING CORPORATI
	Z. KHALIL		SMEC	
CHECK	G. FLEMING			Fa
	L. RYAN		Member of the Surbana Jurong Group (C) ABN 47 065 475 149	
ECK	G. FLEMING		LEVEL 6, 3 HORWOOD PLACE	NSW CO
IANAGER	G. FLEMING		PARRAMATTA NSW. 2150 PH +61 2 9900 7100	GOVERNMENT Se
IRECTOR	C. MILES		SMEC PROJECT No. 300177343.5	

ALL PIPES TO BE SPIGOT AND SOCKET, RUBBER RING JOINTED.

2. ALL LONGITUDINAL PIPELINES IN ROADS MUST BE LOCATED UNDER KERB AND GUTTER AND BE BACKFILLED WITH APPROVED GRANULAR MATERIAL UNLESS OTHERWISE APPROVED BY THE COUNCIL ENGINEER

DRAINAGE LINES MUST BE BACKFILLED WITH APPROVED GRANULAR MATERIAL IN TRAFFICABLE AREAS. THREE (3) METRES OF SUBSOIL DRAINAGE WRAPPED IN GEOTEXTILE STOCKING MUST BE PROVIDED TO ALL DOWNSTREAM PITS. 4. ALL GULLY PITS TO COUNCIL'S STANDARD AND LINTELS CENTRALLY PLACED AT SAG PITS.

5. ALL PITS MUST BE BENCHED AND STREAMLINED. PROVIDE SL72 REINFORCEMENT AND GALVANISED STEP IRONS IN ALL PITS OVER 1.2 METRES DEEP AS MEASURED FROM THE TOP OF GRATE TO THE INVERT OF THE PIT 6. CONCRETE IS TO HAVE MINIMUM COMPRESSIVE STRENGTH OF 32MPa AT 28-DAYS UNLESS OTHERWISE APPROVED BY

7. ALL INTERALLOTMENT DRAINAGE MUST HAVE A MINIMUM PIPE DIAMETER OF 150mm AND A MINIMUM GRADE OF 1%

8. ALL INTERALLOTMENT DRAINAGE LINES MUST BE LAID CENTRALLY WITHIN DRAINAGE EASEMENTS. INSPECTION PITS MUST BE PROVIDED AT ALL CHANGES OF GRADE AND DIRECTION.

9. INTERALLOTMENT DRAINAGE LINES MUST BE INSTALLED AFTER SYDNEY WATER SEWERAGE LINES HAVE BEEN INSTALLED WHERE SEWER IS PROPOSED ADJACENT TO INTERALLOTMENT DRAINAGE LINES

10. ADEQUATE PROVISION IS TO BE MADE TO PREVENT SCOURING AND SEDIMENTATION FOR ALL DRAINAGE WORKS IN

11. PIT LINTELS ARE TO BE STENCILED WITH APPLICABLE DISTINCTION STENCIL AVAILABLE FROM COUNCIL. 12. CATCH DRAINS MUST BE CONSTRUCTED AS REQUIRED BY THE APPROVED PLANS OR THE PRINCIPAL CERTIFYING

13. SOIL AND WATER MANAGEMENT PLANS ARE TO BE PREPARED FOR ALL DISTURBED SITES AND ADHERED TO AT ALL TIMES DURING THE CONSTRUCTION AND MAINTENANCE PERIODS.

THE CONTRACTOR SHALL IMPLEMENT EROSION AND SEDIMENT CONTROL MEASURES AS NECESSARY, AND TO THE SATISFACTION OF COUNCIL PRIOR TO THE COMMENCEMENT OF CONSTRUCTION AND DURING CONSTRUCTION MAINTENANCE OF THE EROSION AND SEDIMENT CONTROL IS TO BE UNDERTAKEN ON A REGULAR BASIS & AS PER

TESTS SHALL BE UNDERTAKEN ON ANY PROPOSED FILL MATERIALS TO ENSURE THAT THEY DO NOT HAVE A HIGH DISPERSION POTENTIAL AS DEFINED BY THE EMERSON CRUMB/DISPERSION TESTS (AS1289 C8-1980). 3. ALL FILL SHALL BE COMPACTED TO NOT LESS THAN 95% OF STANDARD MAXIMUM DRY DENSITY AT -3% TO +3% OF STANDARD OPTIMUM MOISTURE CONTENT (MAXIMUM FILL HORIZONS OF 150mm TO 200mm). ALL AREAS WHICH HAVE TEST RESULTS LESS THAN 98% STANDARD SHOULD BE REWORKED AND RETESTED TO ENSURE COMPLIANCE, IN

ALL FILL AREAS TO BE SURVEYED AT STRIPPING AND FINAL STAGES AND LEVELS SHOWN ON PLAN SHADED, (TOGETHER WITH CROSS SECTIONS AT MAXIMUM 20m C/C) AT WORKS-AS-EXECUTED STAGE AND CONTROLLED BY A REGISTERED SURVEYOR. 88B INSTRUMENT REQUIRED FOR ALL LOTS FILLED WITHIN THE BUILDING LINE ALL EARTHWORKS SHALL BE CONTROLLED AND CERTIFIED BY A N.A.T.A. REGISTERED LABORATORY. TWO COLLATED

COPIES OF ALL TEST CERTIFICATES, ACCOMPANIED BY AN OVERALL SITE PLAN, CLEARLY INDICATING THE LOCATION OF EACH TEST AND FILL AREAS ETC., AND THE LABORATORY CERTIFICATE COVERING THE WHOLE OF THE AREA TESTED ARE TO BE FORWARDED TO COUNCIL UPON COMPLETION. TESTING IS TO BE TO LEVEL 1 AS3798 APPENDIX B2(A). ALL RESIDENTIAL LOTS SHALL BE INDIVIDUALLY CLASSIFIED IN ACCORDANCE WITH THE LATEST EDITION OF THE GUIDELINES IN THE AUSTRALIAN STANDARD FOR RESIDENTIAL SLABS AND FOOTINGS AS 2870. PROVIDE TWO COPIES OF

20/6/2021




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PROJECT TITLE


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CAMPBELLTOWN CITY COUNCIL ROSEMEADOW – STAGE 3 SHEET SCHEDULE & NOTES

ALE	PHASE	PROJECT / DRAWING No.	REVISION
S NOTED	PRELIMINARY	300177343.05.DA002	05



Ζ.	KHALIL			
G.	FLEMING			
L.	RYAN			
G.	FLEMING		5 0	10
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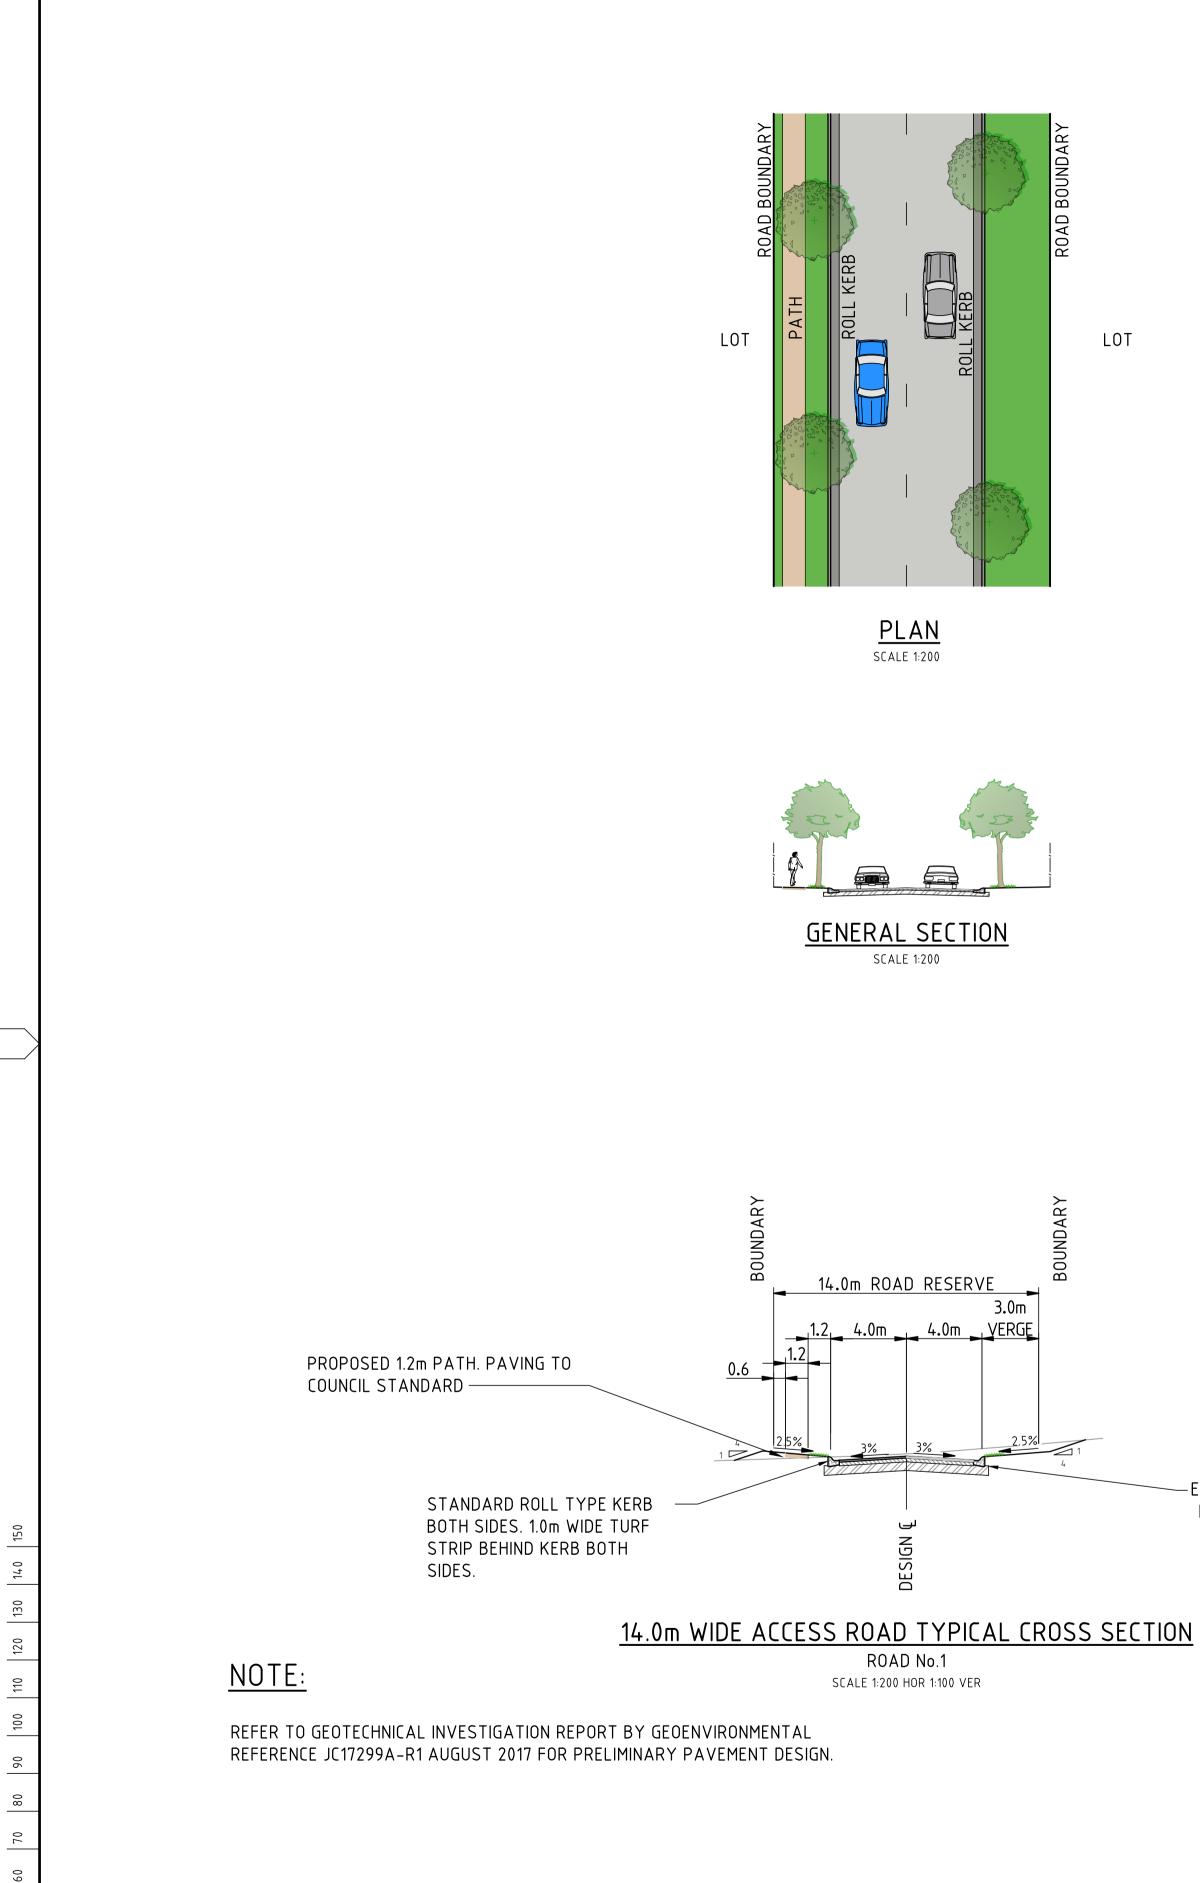


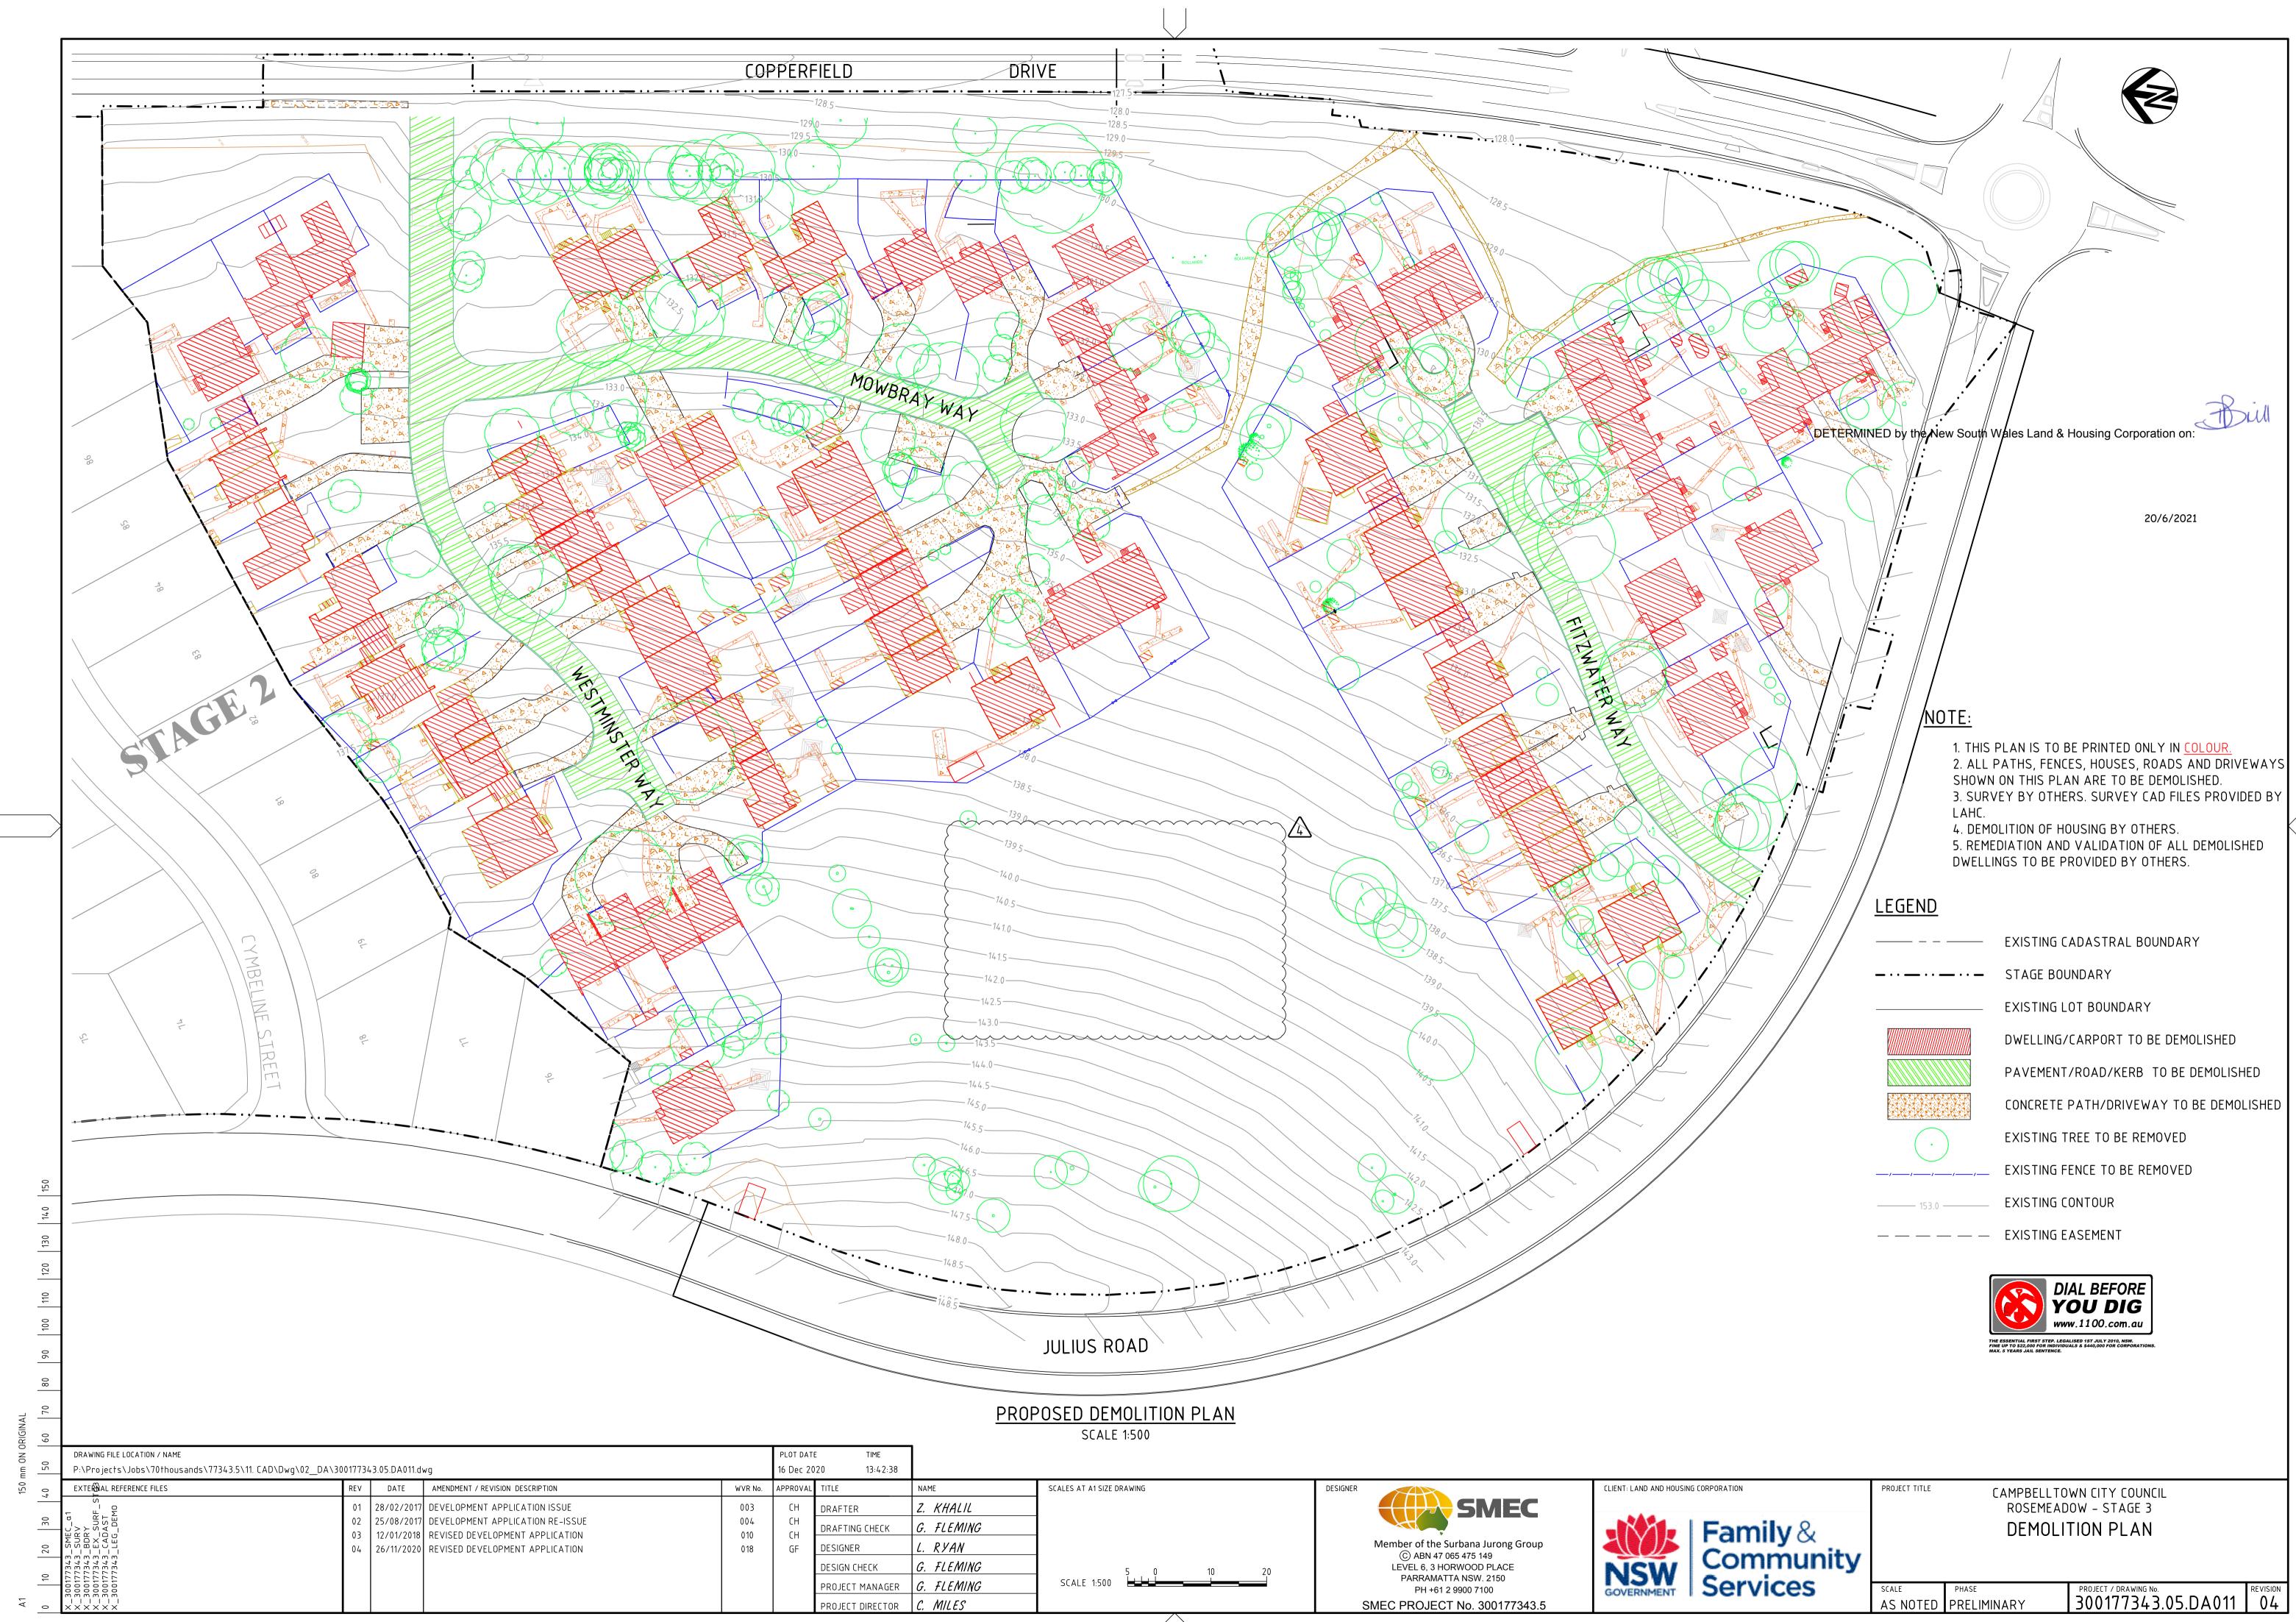DETERMINED by the New South Wales Land & Housing Corporation on:
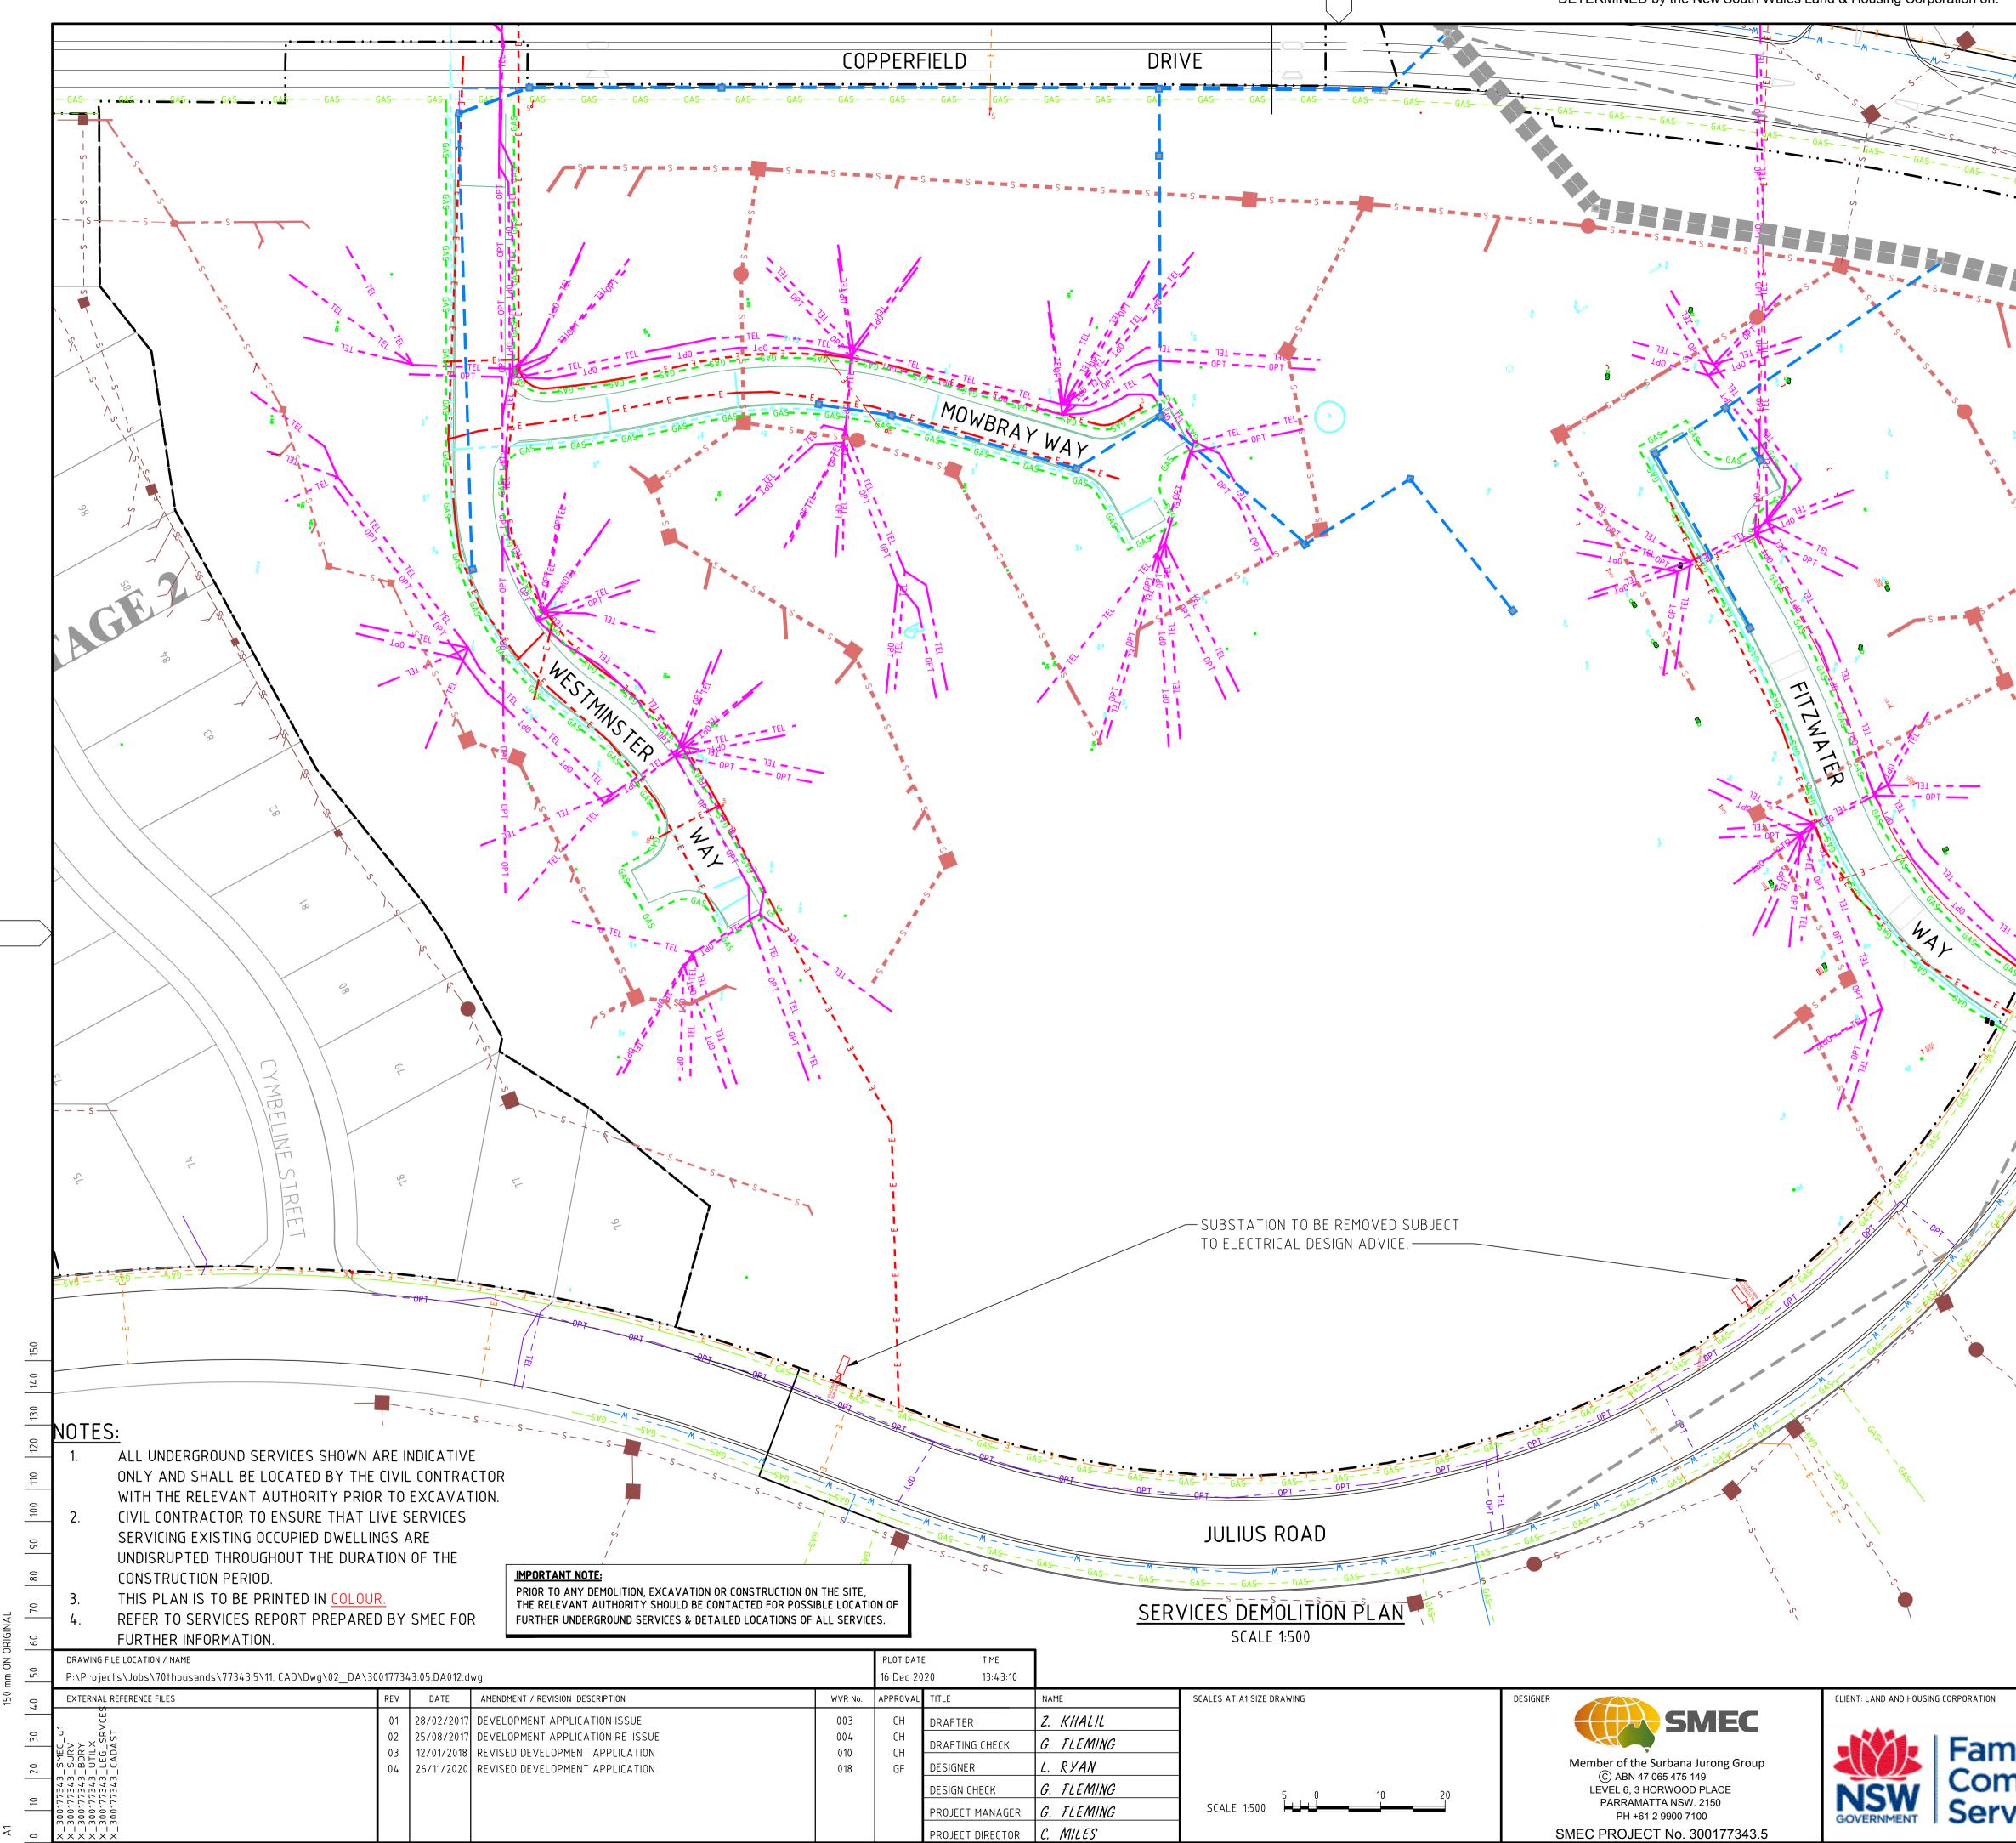
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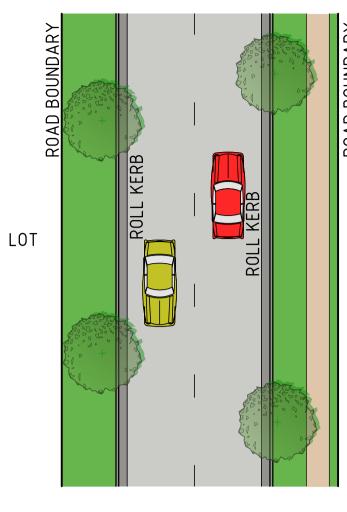
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ten list	<u>LEGEND</u>	
		EXISTING CADASTRAL BOUNDARY
		EXISTING ELECTRICITY & POWER POLE - REMOVE
	E − − − ●	EXISITING ELECTRICITY LINE - RETAINED
		EXISTING TELSTRA (OVERHEAD) – REMOVE
		EXISTING TELSTRA (OVERHEAD) - RETAINED
		EXISTING OPTICE FIBRE LINE – REMOVE EXISTING OPTIC FIBRE LINE – RETAINED
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J.		EXISTING GAS LINE - RETAINED
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	PROJECT TITLE C	CAMPBELLTOWN CITY COUNCIL ROSEMEADOW - STAGE 3
nily &	SER	VICES DEMOLITION PLAN
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20/6/2021




50	DRAWING FILE LOCATION / NAME P:\Projects\Jobs\70thousands\77343.5\11. CAD\Dwg\02_DA\300177343.05.DA041.dwg 16								
40	EXTERNAL REFERENCE FILES	REV	DATE	AMENDMENT / REVISION DESCRIPTION	WVR No.	APPROVAL	TITLE		
-	-	01	28/02/2017	DEVELOPMENT APPLICATION ISSUE	003	СН	DRAFTER		
30		02	25/08/2017	DEVELOPMENT APPLICATION RE-ISSUE	004	СН	DRAFTING CHEC		
	SMEC T≺P-	03	11/09/2017	LAHC AMENDMENTS	005	СН			
V		04	12/01/2018	REVISED DEVELOPMENT APPLICATION	010	СН	DESIGNER		
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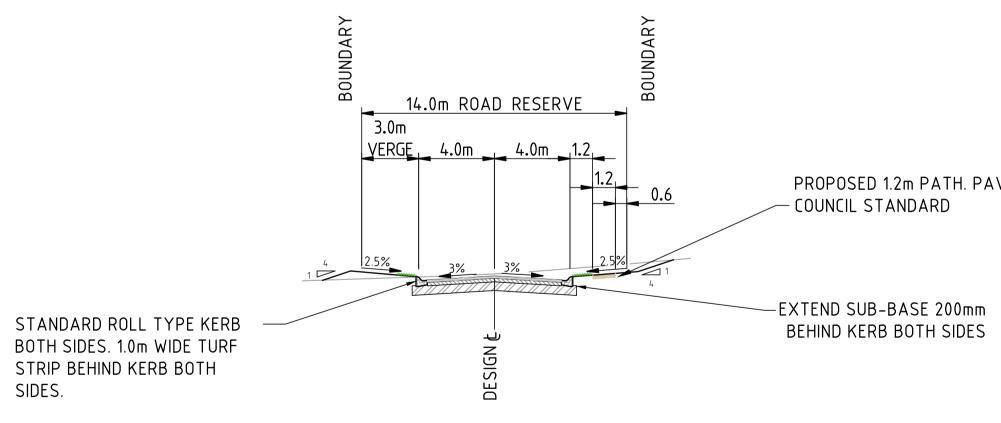
A1





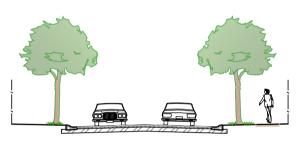

GENERAL SECTION SCALE 1:200



14.0m WIDE ACCESS ROAD TYPICAL CROSS SECTION

ROAD No.2 SCALE 1:200 HOR 1:100 VER

ΓIME 3:43:36 SCALES AT A1 SIZE DRAWING CLIENT: LAND AND HOUSING CORPORATION NAME DESIGNER SMEC Z. KHALIL G. FLEMING HECK Fan SCALE 1:100 Member of the Surbana Jurong Group L. RYAN Cor © ABN 47 065 475 149 G. FLEMING **NSW** GOVERNMENT LEVEL 6, 3 HORWOOD PLACE PARRAMATTA NSW. 2150 Ser SCALE 1:200 G. FLEMING ANAGER PH +61 2 9900 7100 RECTOR C. MILES SMEC PROJECT No. 300177343.5

-EXTEND SUB-BASE 200mm BEHIND KERB BOTH SIDES


	PROJECT TITLE		WN CITY COUNCIL OW – STAGE 3							
nily &	TYPICAL ROAD CROSS SECTION									
nmunity										
vices	^{scale} AS NOTED	PHASE PRELIMINARY	PR0JECT / DRAWING №. 300177343.05.DA041	REVISION						


PROPOSED 1.2m PATH. PAVING TO

LOT

20/6/2021


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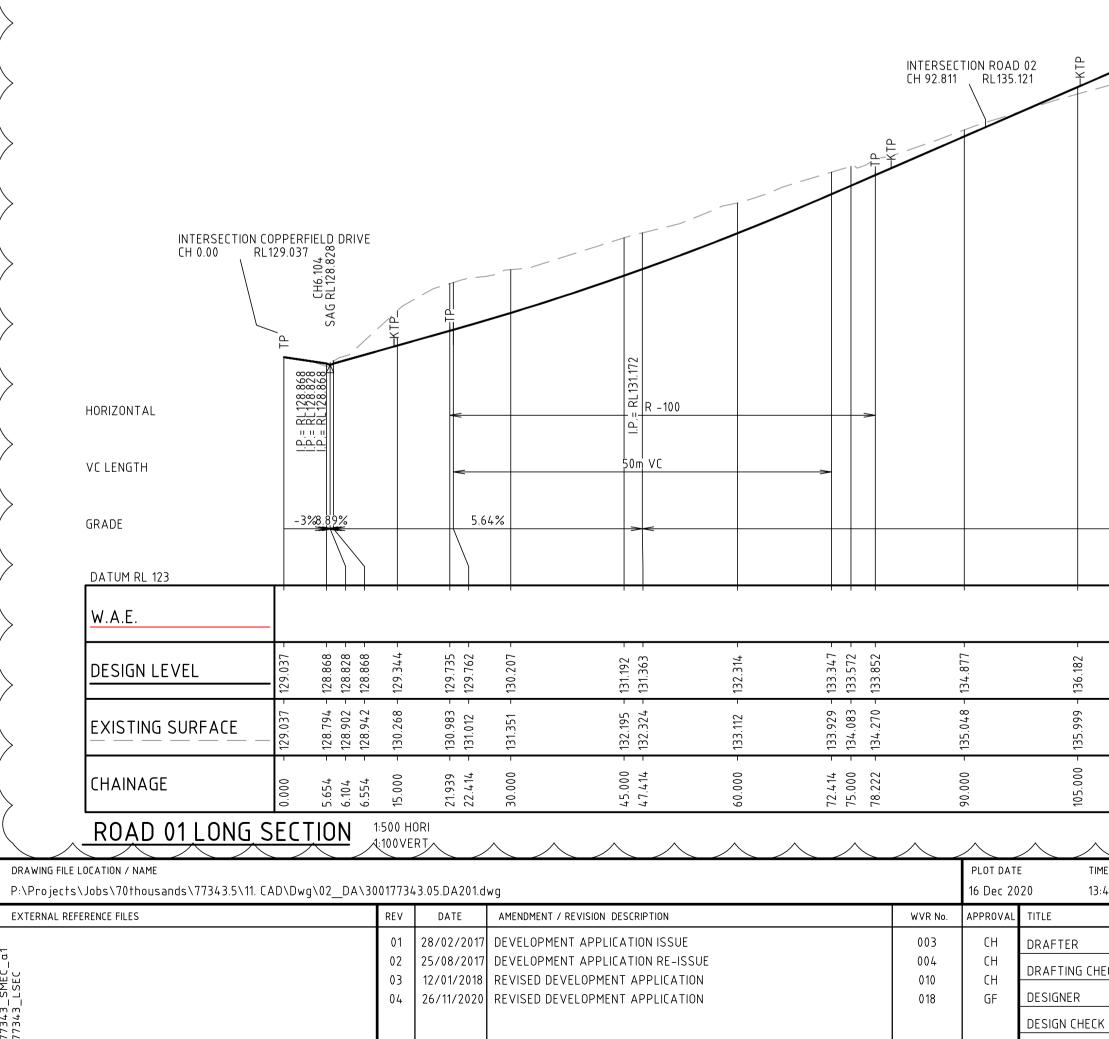
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ROAD 02 LONG SECTION 1:500 HORI 1:100VERT

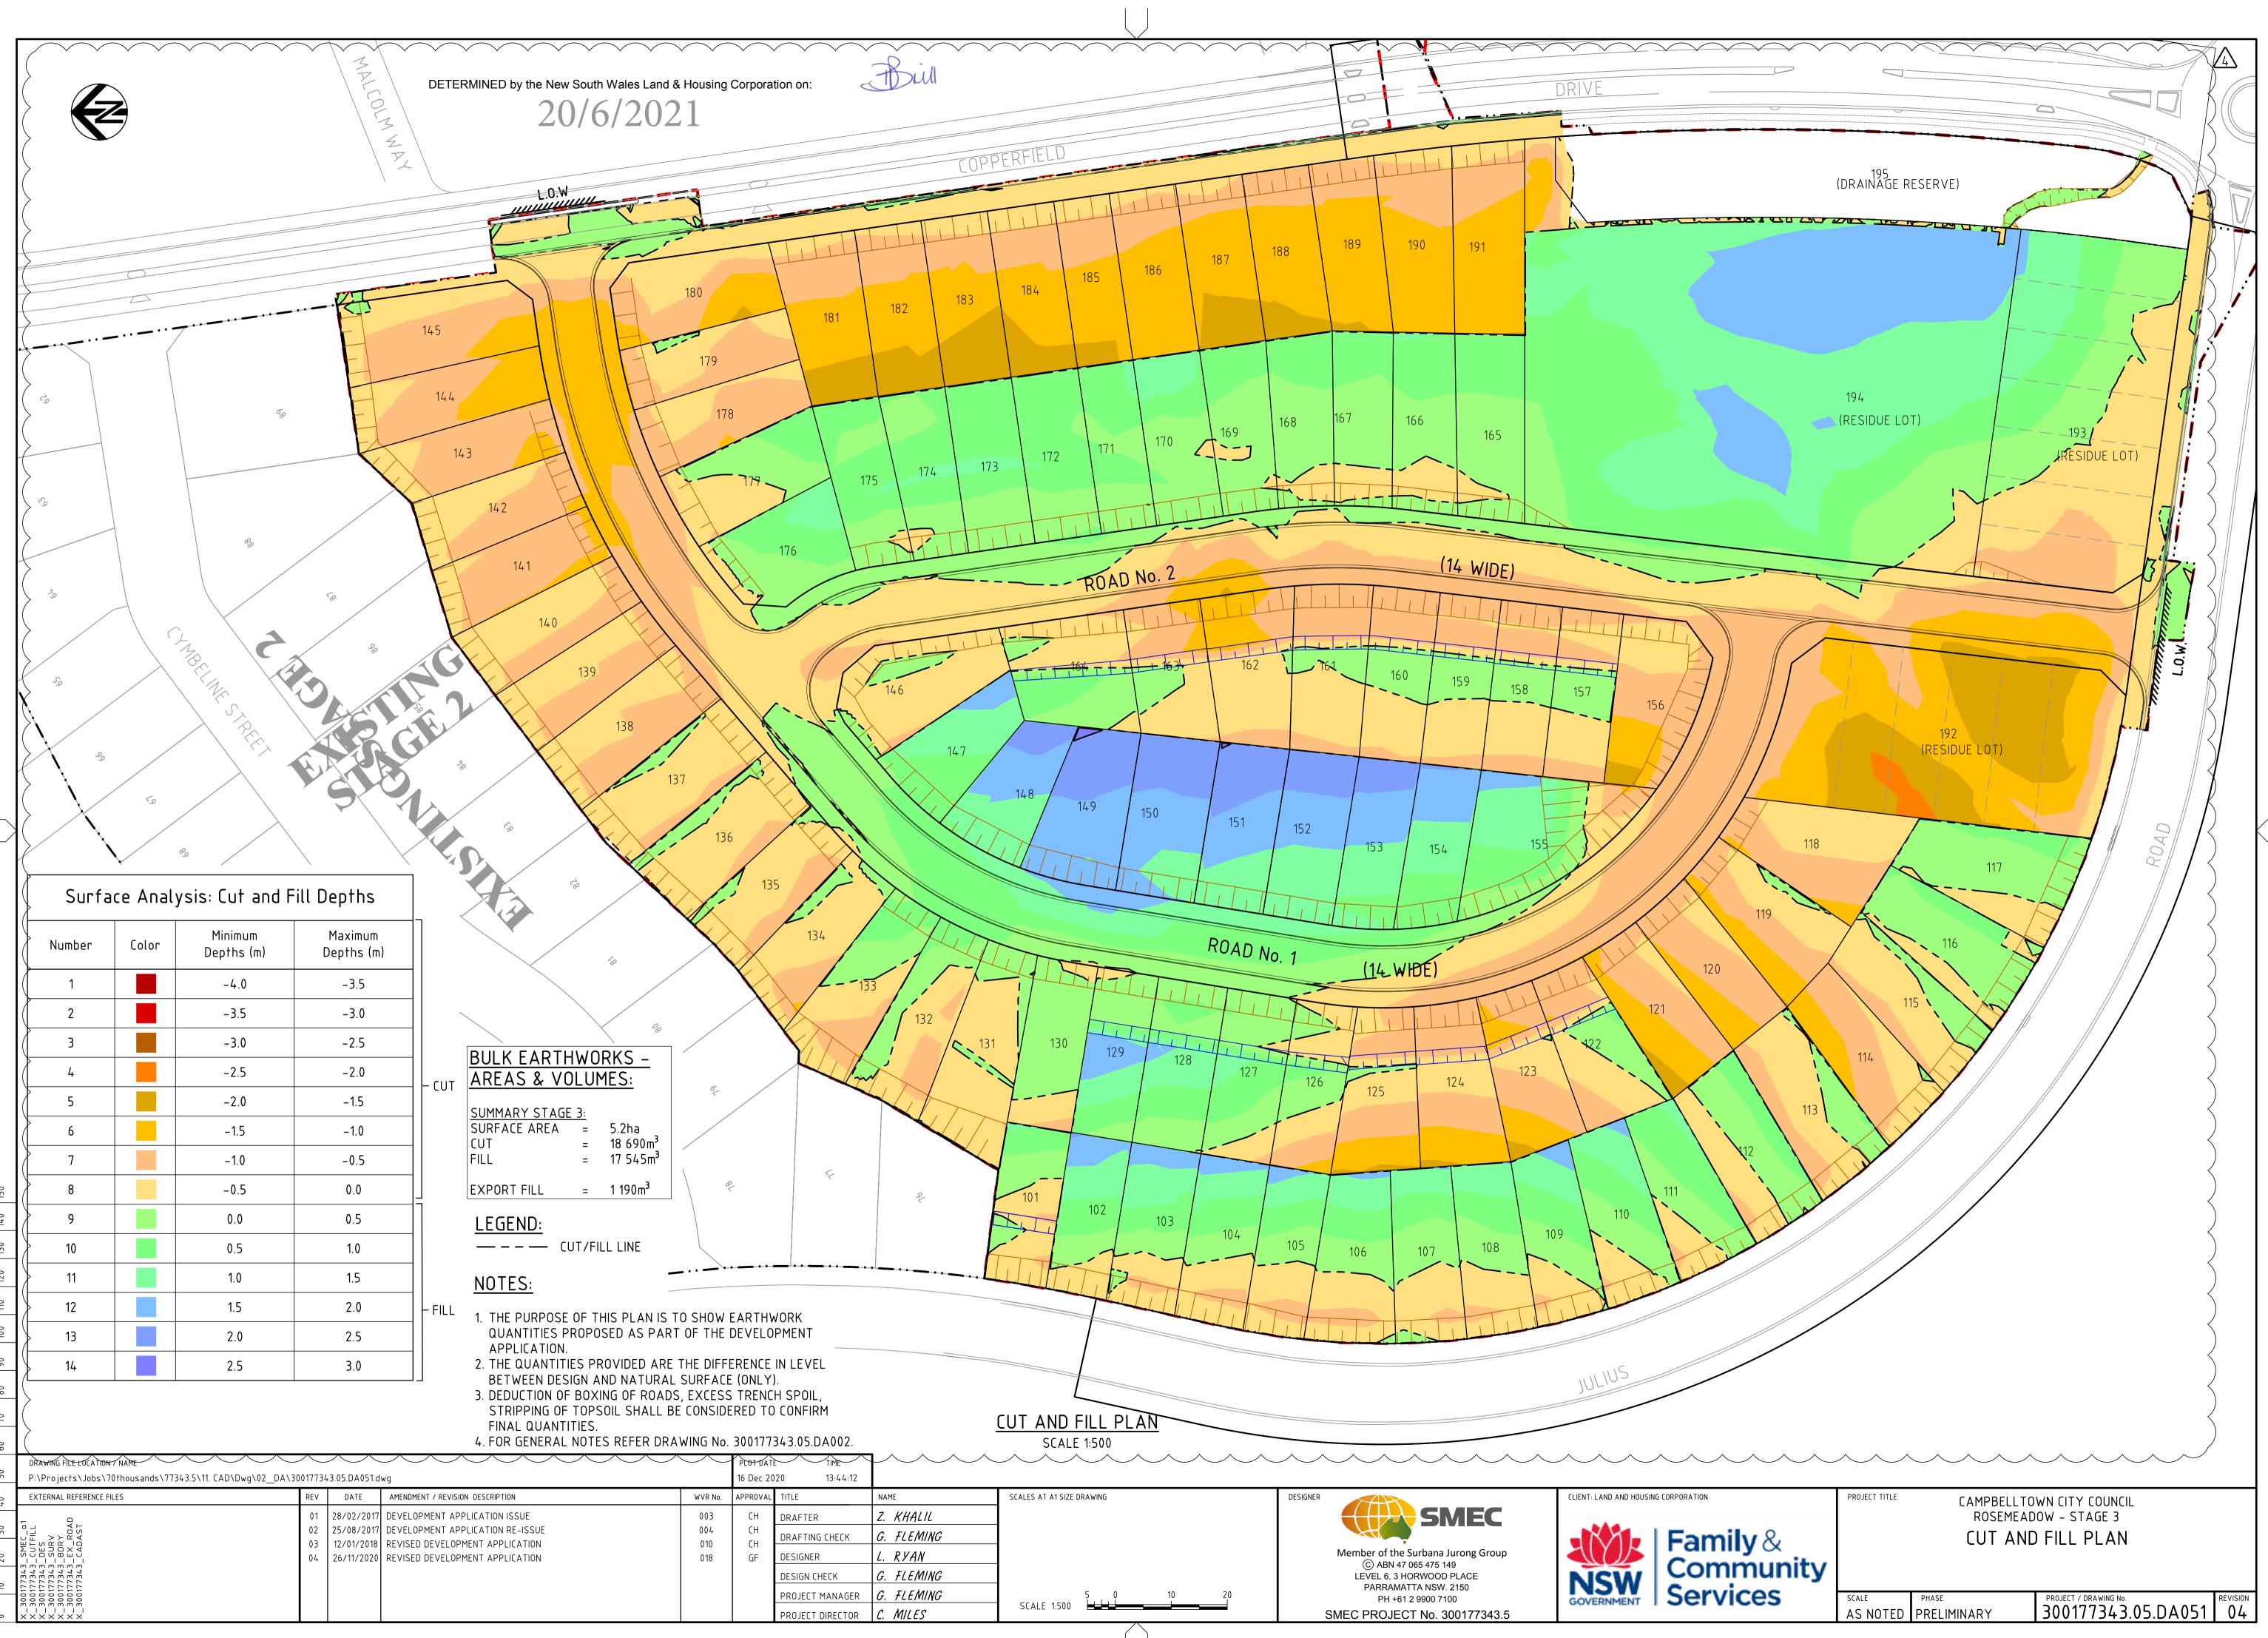L.O.W.

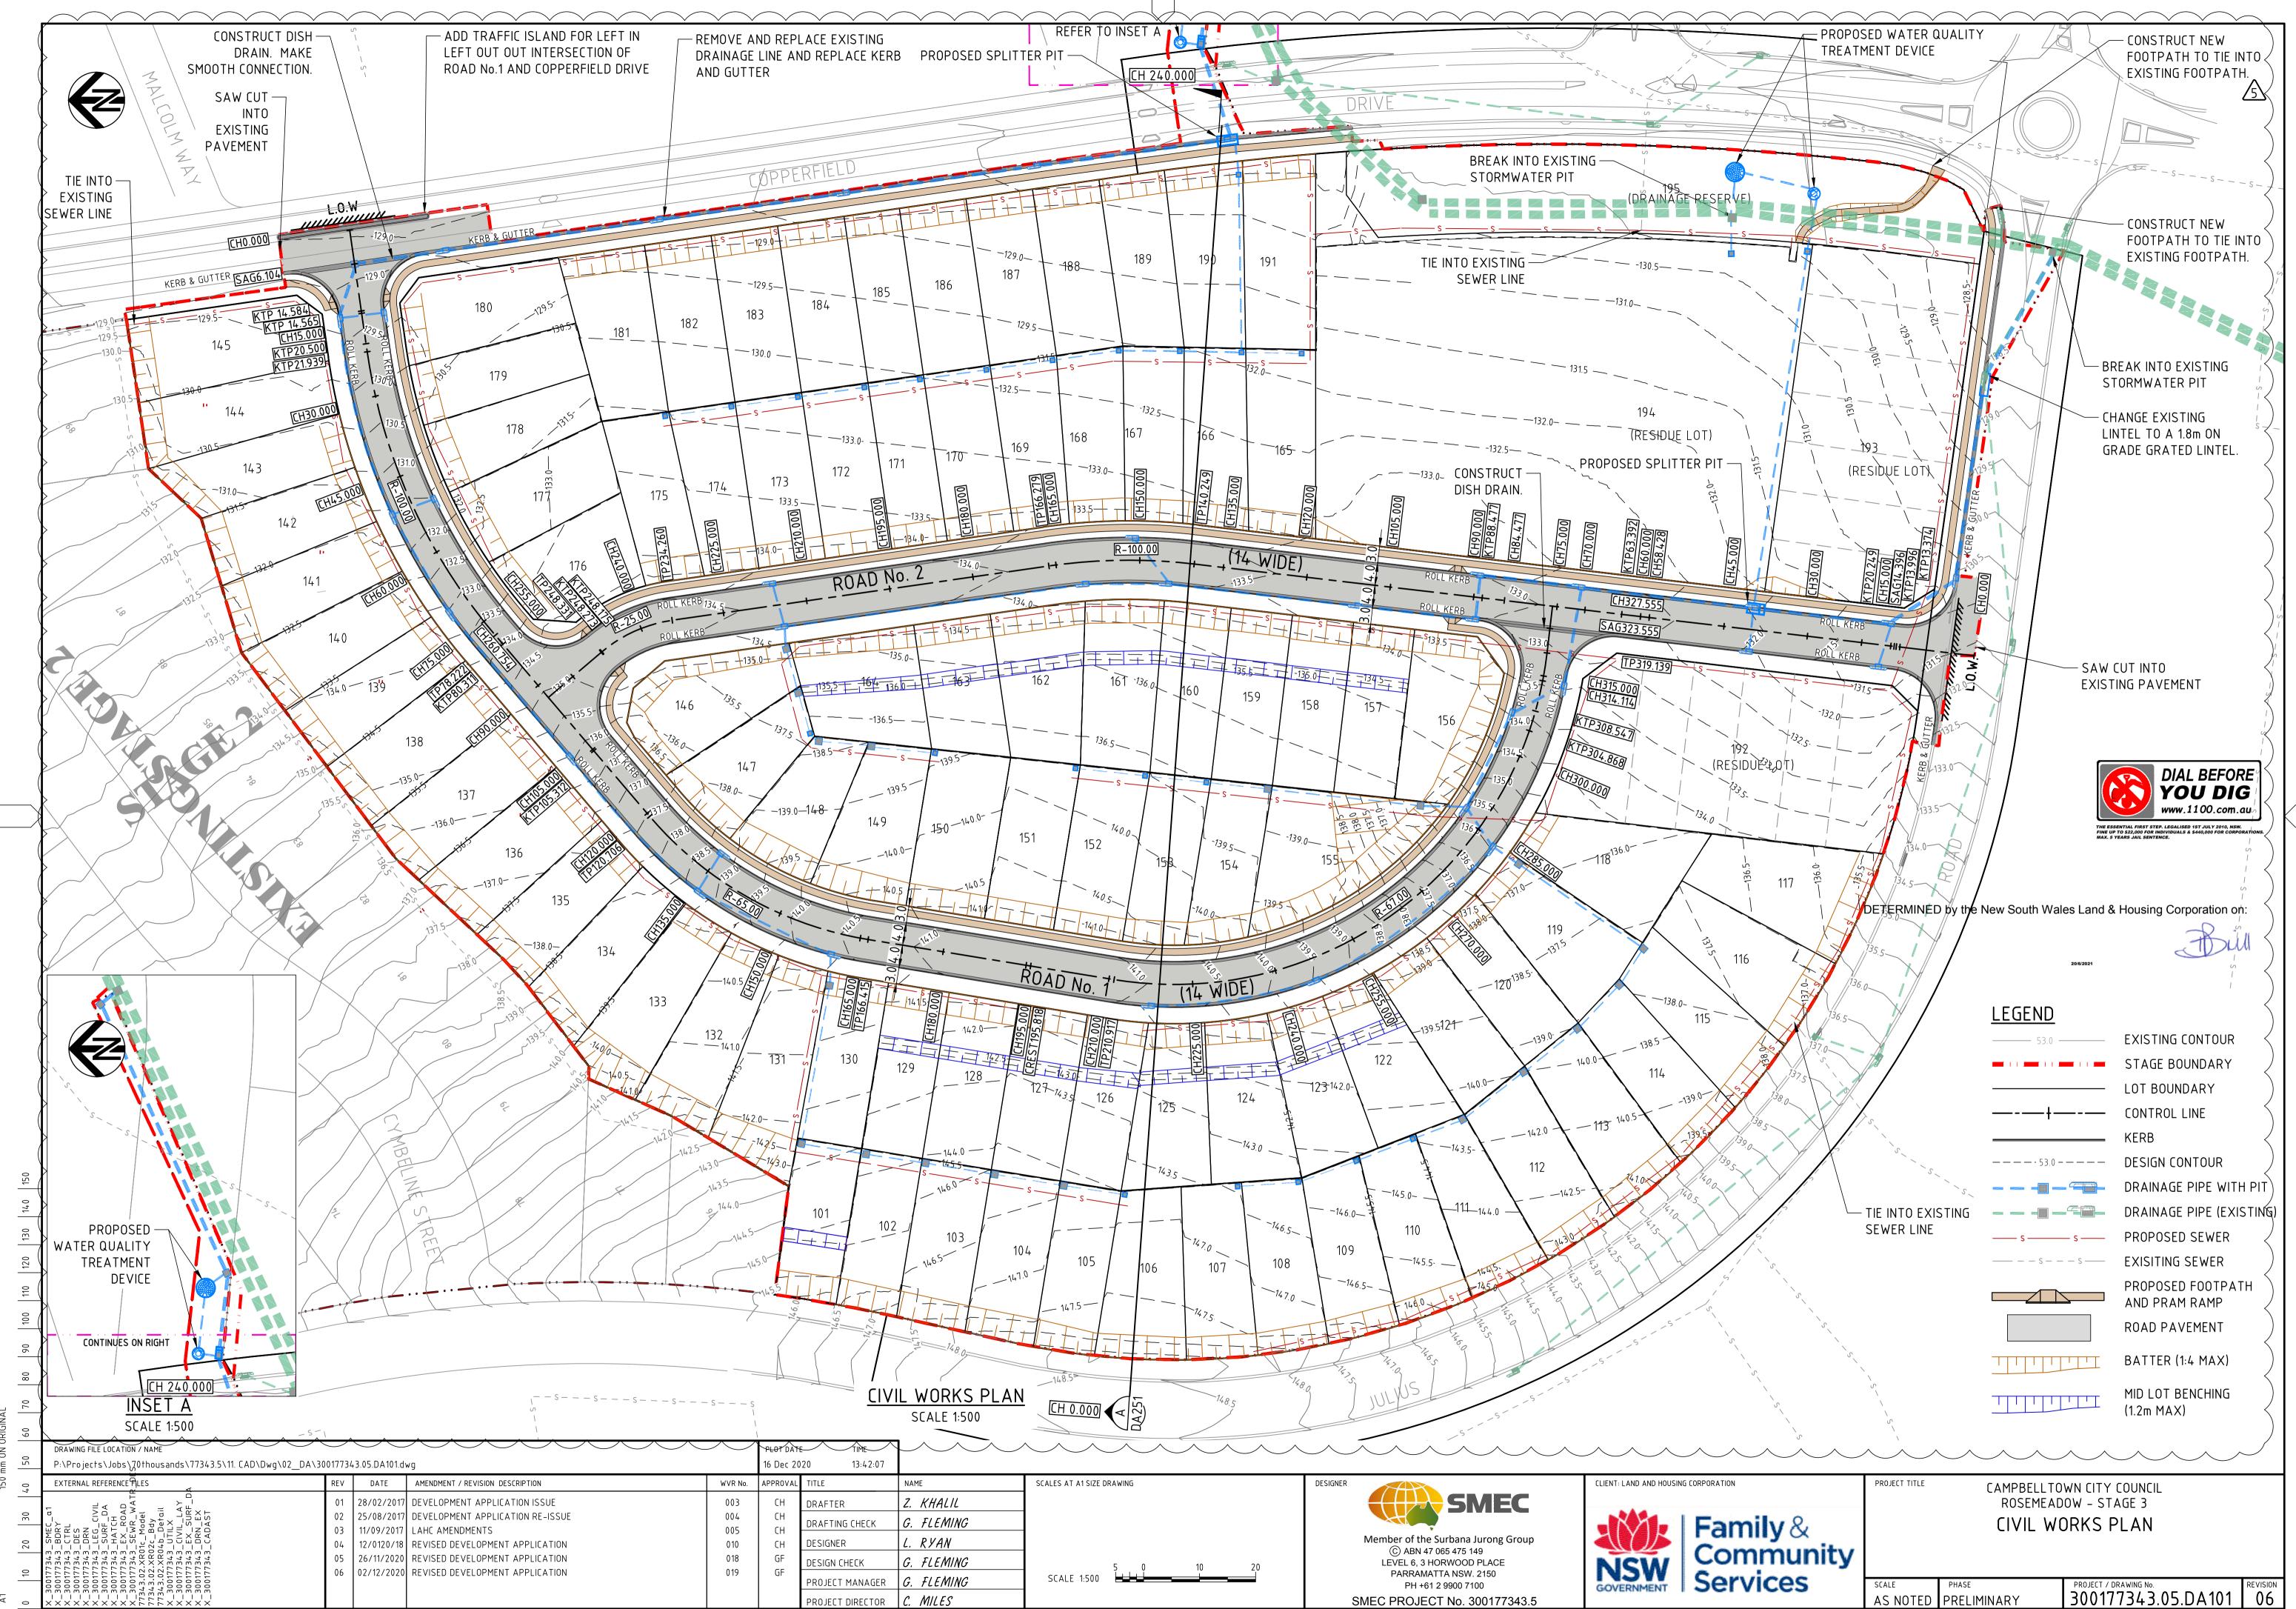


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DETERMINED by the New South Wales Land & Housing Corporation on:

			F	ROPOSED WORK							
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	d										
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	10 - 137.125 - 16 - 137.188 -	3 - 137.917 - 10 - 138.076 -	0 - 138.971 -	0 - 139.654 - 5 - 139.692 -	0 - 14.0.115 -	0 - 140.540 - 8 - 140.548 -	13 - 140.617 - 00 - 140.689 - 7 - 140.699 -	00 - 140.630 -	00 - 140.309 -	00 - 139.385 -	
TIME 13:42:34	120.000	131.913	150.000	165.000	180.000	195.000	204.413	225.000 -	240.000 -	255.000 -	
	NAME Z. KHALIL		SCALES AT A1 SIZE DRAWIN	G			S	MEC		AND HOUSING CORPORA	ΓΙΟΝ

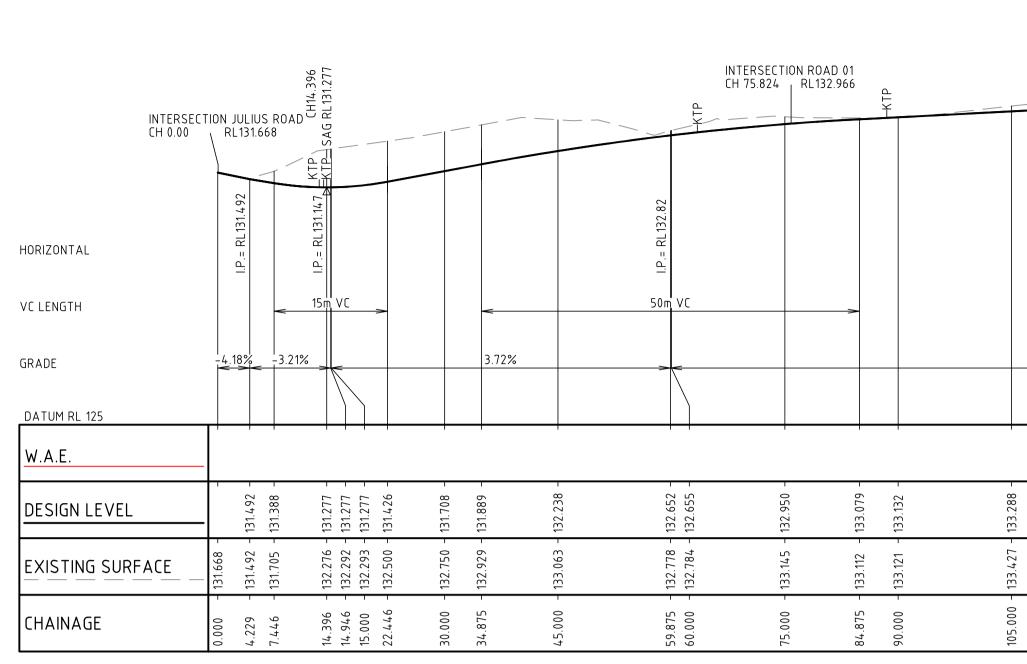DRAFTER	Z. KHALIL				
DRAFTING CHECK	G. FLEMING				
DESIGNER	L. RYAN			Member of the Surbana Jurong Group ⓒ ABN 47 065 475 149	
DESIGN CHECK	G. FLEMING	HORIZ. 1:500 5	0 5 10 15 20 25	LEVEL 6, 3 HORWOOD PLACE	NIGW/ C
PROJECT MANAGER	G. FLEMING	╞╪╪╡		PARRAMATTA NSW. 2150 PH +61 2 9900 7100	GOVERNMENT SC
PROJECT DIRECTOR	C. MILES	VERT. 1:100 1	0 1 2 3 4 5	SMEC PROJECT No. 300177343.5	
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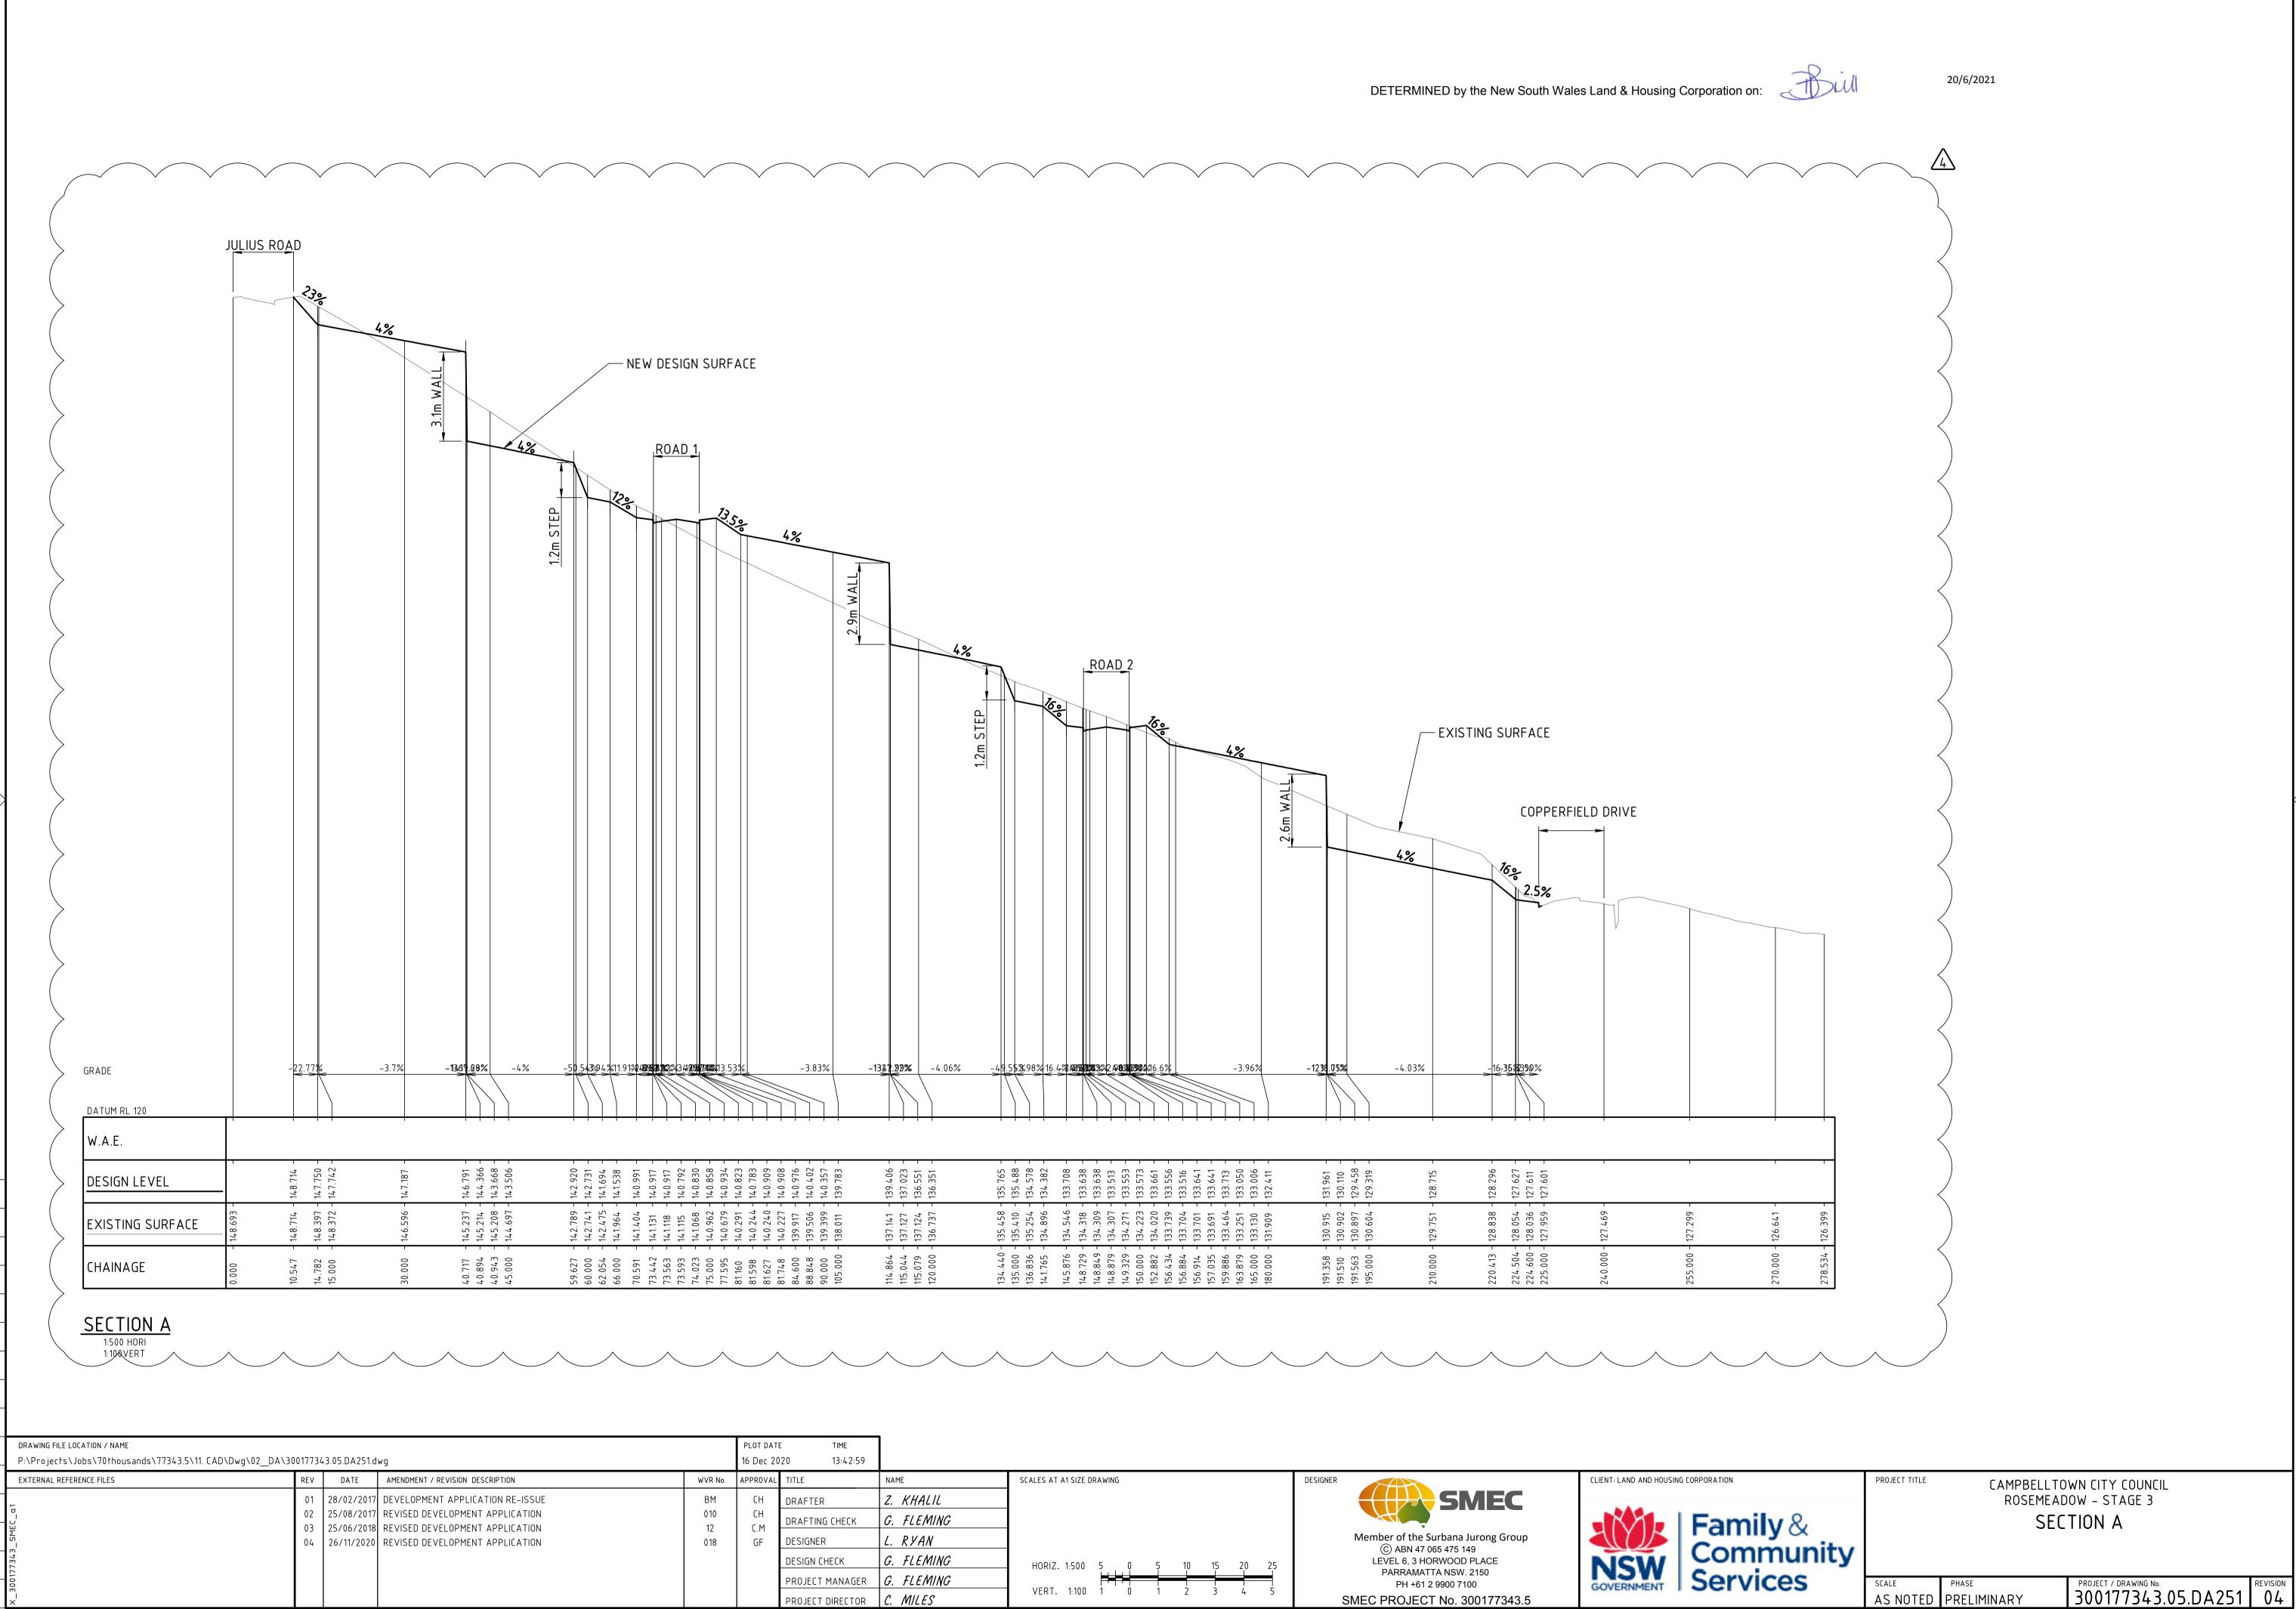
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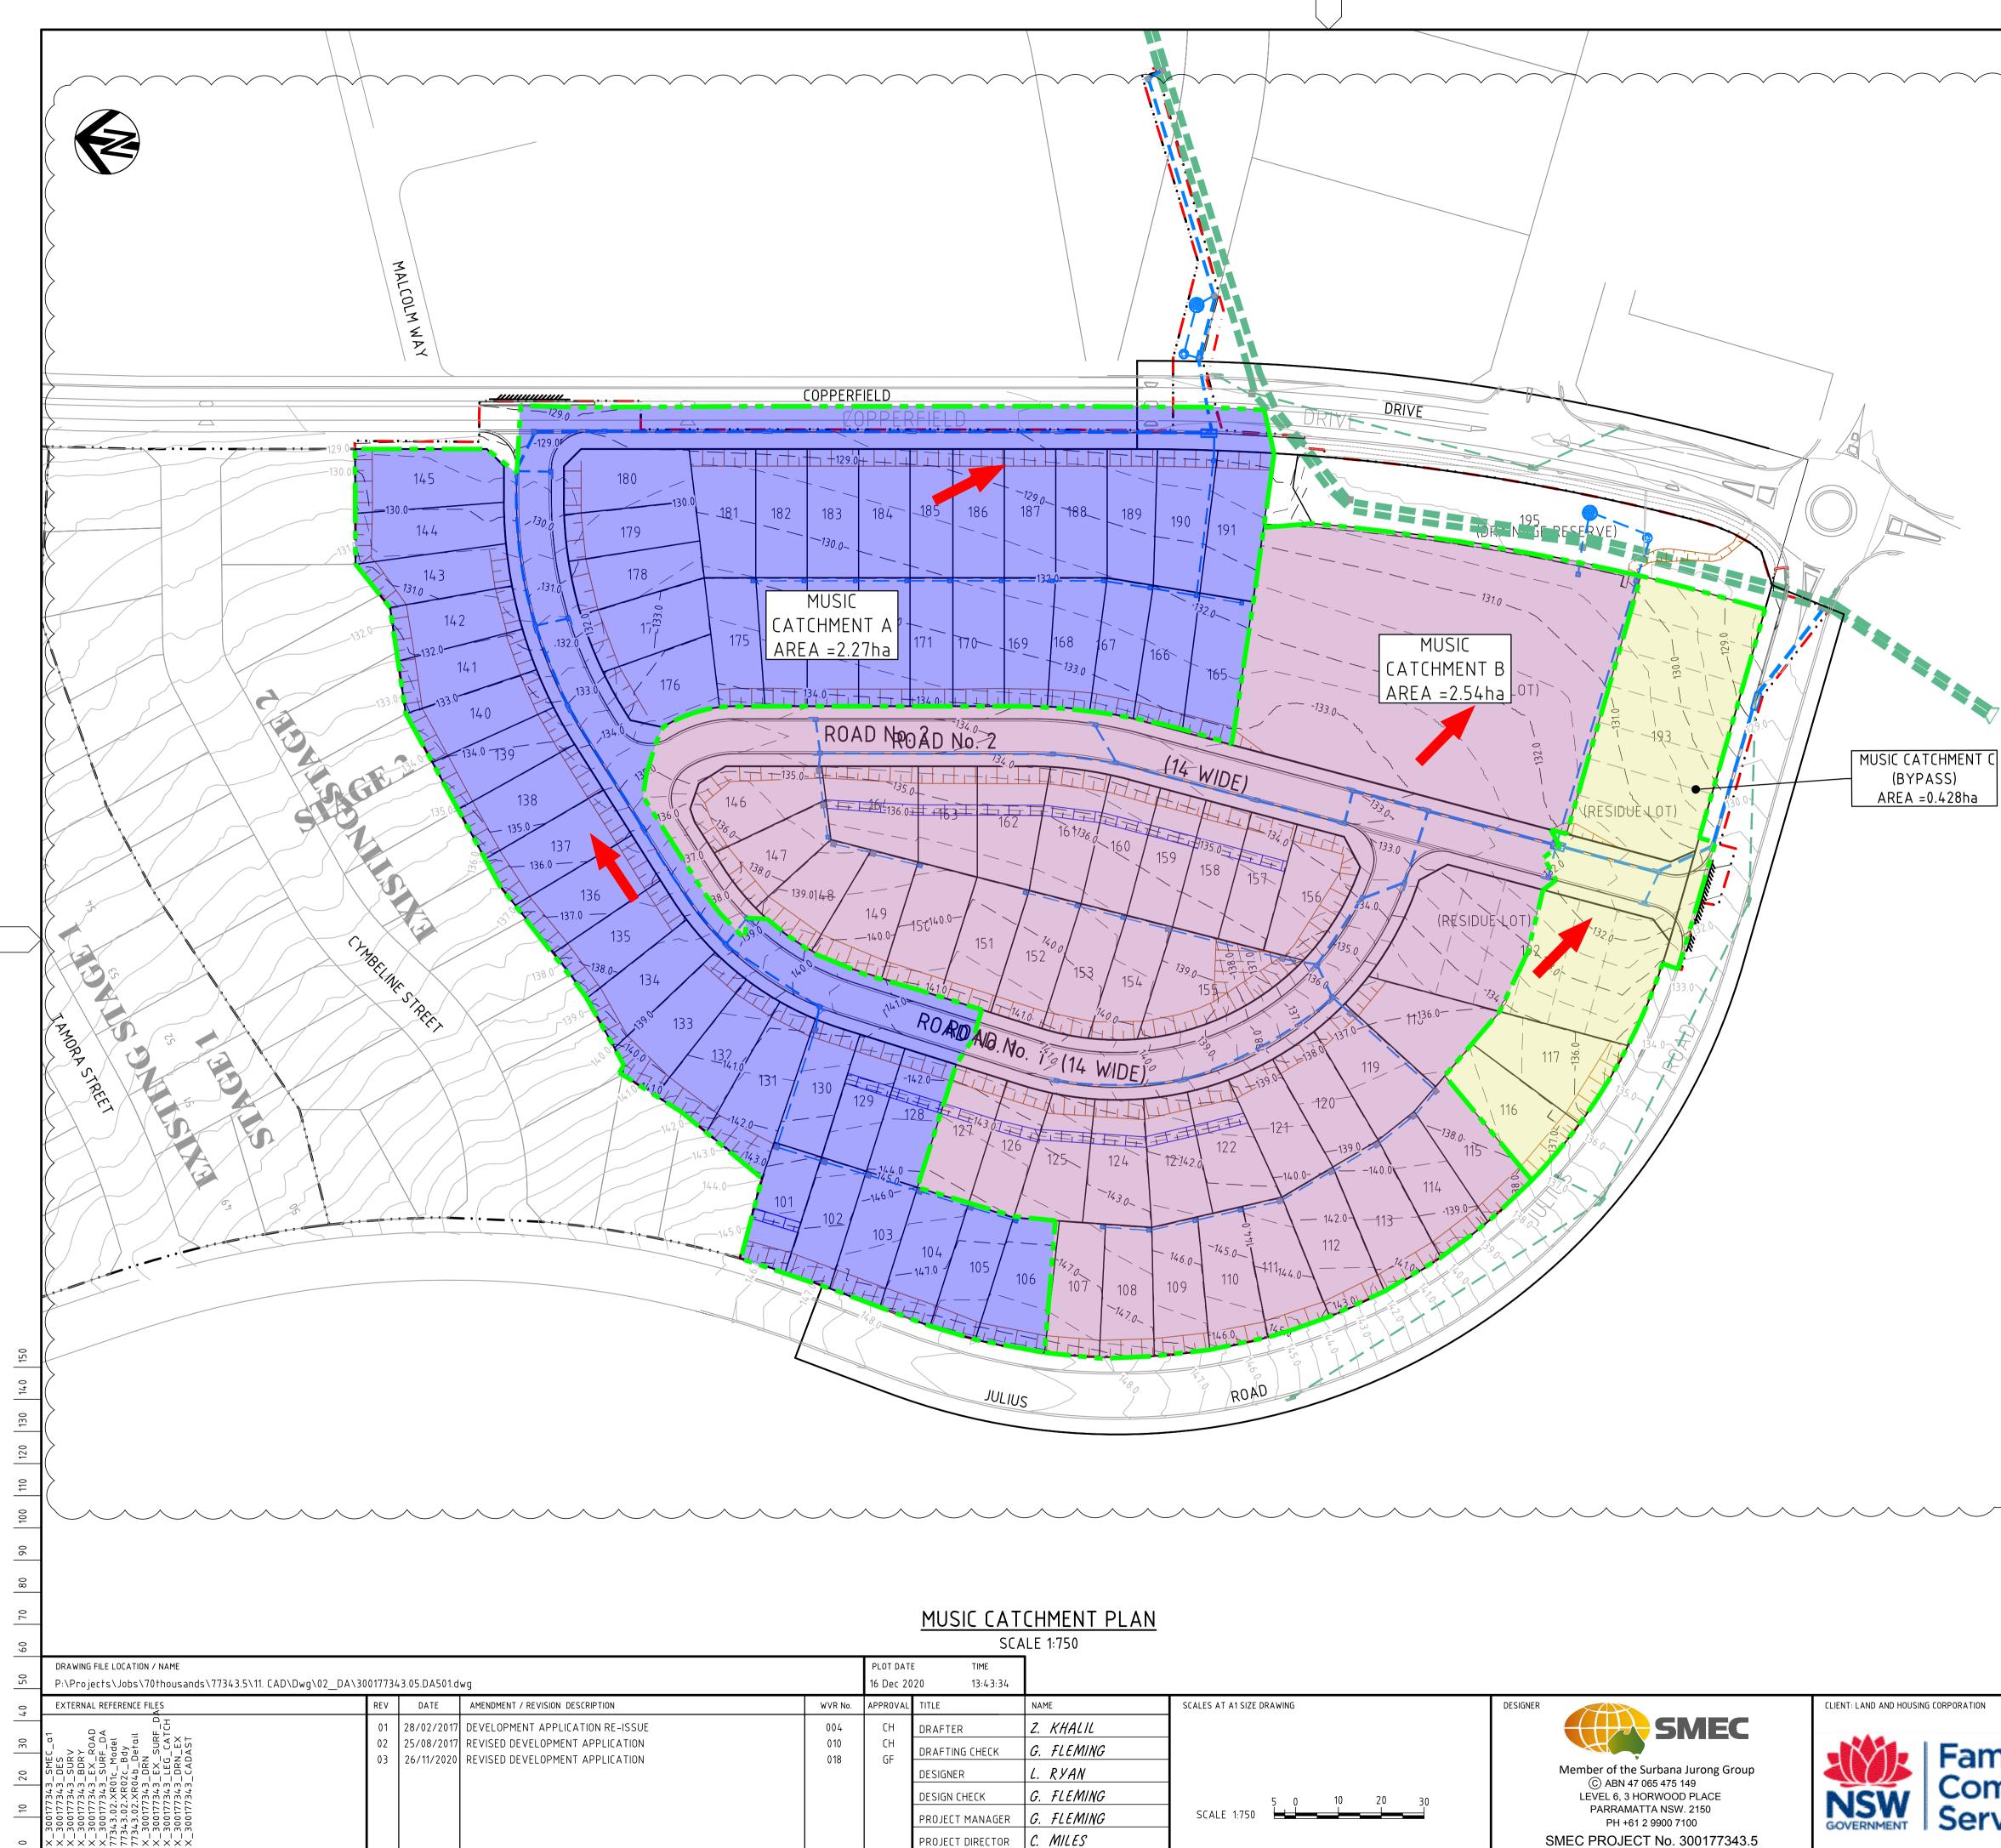
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150 1	0 +	EXTERNAL REFERENCE FILES	REV	DATE	AMENDMENT / REVISION DESCRIPTION	WVR No.	APPROVAL	TITLE	
	'	-	01	28/02/2017	DEVELOPMENT APPLICATION RE-ISSUE	BM	СН	DRAFTER	
	30		02	25/08/2017	REVISED DEVELOPMENT APPLICATION	010	СН	DRAFTING CHE	
		ΔE	03	25/06/2018	REVISED DEVELOPMENT APPLICATION	12	C.M		
	20		04	26/11/2020	REVISED DEVELOPMENT APPLICATION	018	GF	DESIGNER	
		734.						DESIGN CHECK	
	10	0017						PROJECT MAN	
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4	0	×						PROJECT DIREC	

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IME				
3:42:59				
	NAME	SCALES AT A1 SIZE DRAWING	DESIGNER	CLIENT: LAND AND HOUSING CORPORATION
	Z. KHALIL		SMEC	
HECK	G. FLEMING			- Fan
	L. RYAN		Member of the Surbana Jurong Group ⓒ ABN 47 065 475 149	Cor
IK I	G. FLEMING	HORIZ. 1:500 5 0 5 10 15 20 25	LEVEL 6, 3 HORWOOD PLACE	
NAGER	G. FLEMING		PARRAMATTA NSW. 2150 PH +61 2 9900 7100	GOVERNMENT Ser
RECTOR	C. MILES	VERT. 1:100 1 0 1 2 3 4 5	SMEC PROJECT No. 300177343.5	

AS NOTED PRELIMINARY

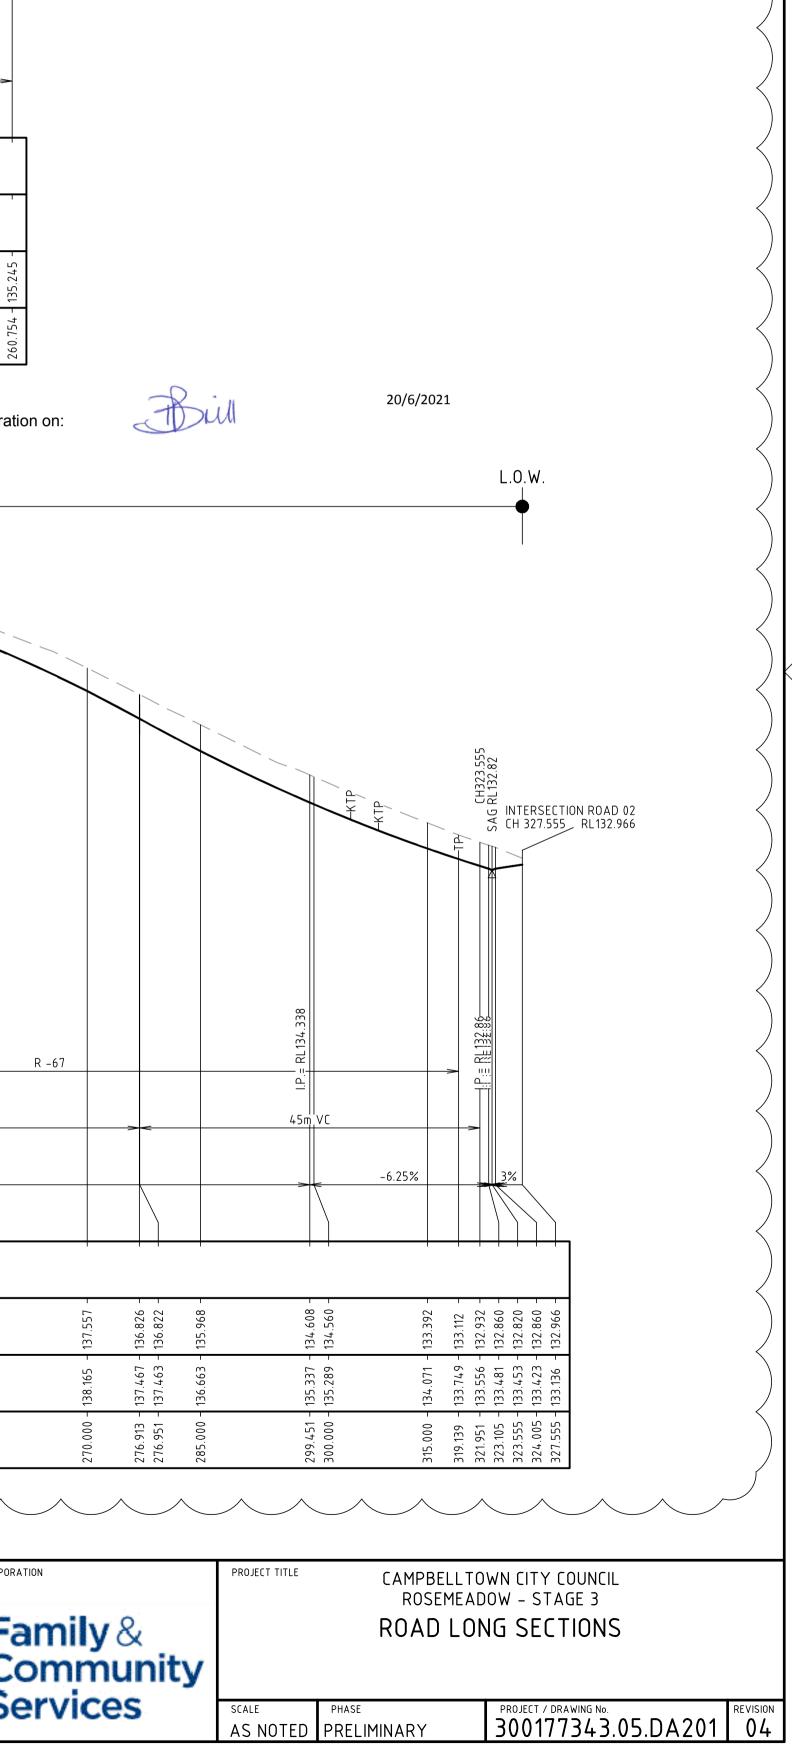

SCA	LE 1:750			
TIME				
13:43:34				
	NAME	SCALES AT A1 SIZE DRAWING	DESIGNER	CLIENT: LAND AND HOUSING CORPORATION
2	Z. KHALIL		SMEC	
G CHECK	G. FLEMING			Fam
2	L. RYAN		Member of the Surbana Jurong Group ⓒ ABN 47 065 475 149	Con
HECK	G. FLEMING	5 0 10 20 30	LEVEL 6, 3 HORWOOD PLACE	NICW CON
MANAGER	G. FLEMING	SCALE 1:750	PARRAMATTA NSW. 2150 PH +61 2 9900 7100	GOVERNMENT Serv
DIRECTOR	C. MILES		SMEC PROJECT No. 300177343.5	

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_ · · · ·	EXISTING CADASTRAL BOUNDARY
53.0	EXISTING CONTOUR
<u> </u>	DESIGN CONTOUR
	ROAD BOUNDARY
	LOT BOUNDARY
	FUTURE LOT BOUNDARY
	DRAINAGE PIPE WITH PIT
	DRAINAGE PIPE WITH PIT (EXISTING)
-	FLOW DIRECTION
	MUSIC CATCHMENTA
000000	MUSIC CATCHMENT B
	MUSIC CATCHMENT C

DETERMINED by the New South Wales Land & Housing Corporation on:


Bill


20/6/2021



THE ESSENTIAL FIRST STEP. LEGALISED 1ST JULY 2010, NSW. FINE UP TO \$22,000 FOR INDIVIDUALS & \$440,000 FOR CORPORATION MAX. 5 YEARS JAIL SENTENCE.

mily& mmunity	PROJECT TITLE	ROSEMEAD	WN CITY COUNCIL OW – STAGE 3 CHMENT PLAN	
rvices	^{scale} AS NOTED	PHASE PRELIMINARY	PROJECT / DRAWING NO. 300177343.05.DA501	REVISION

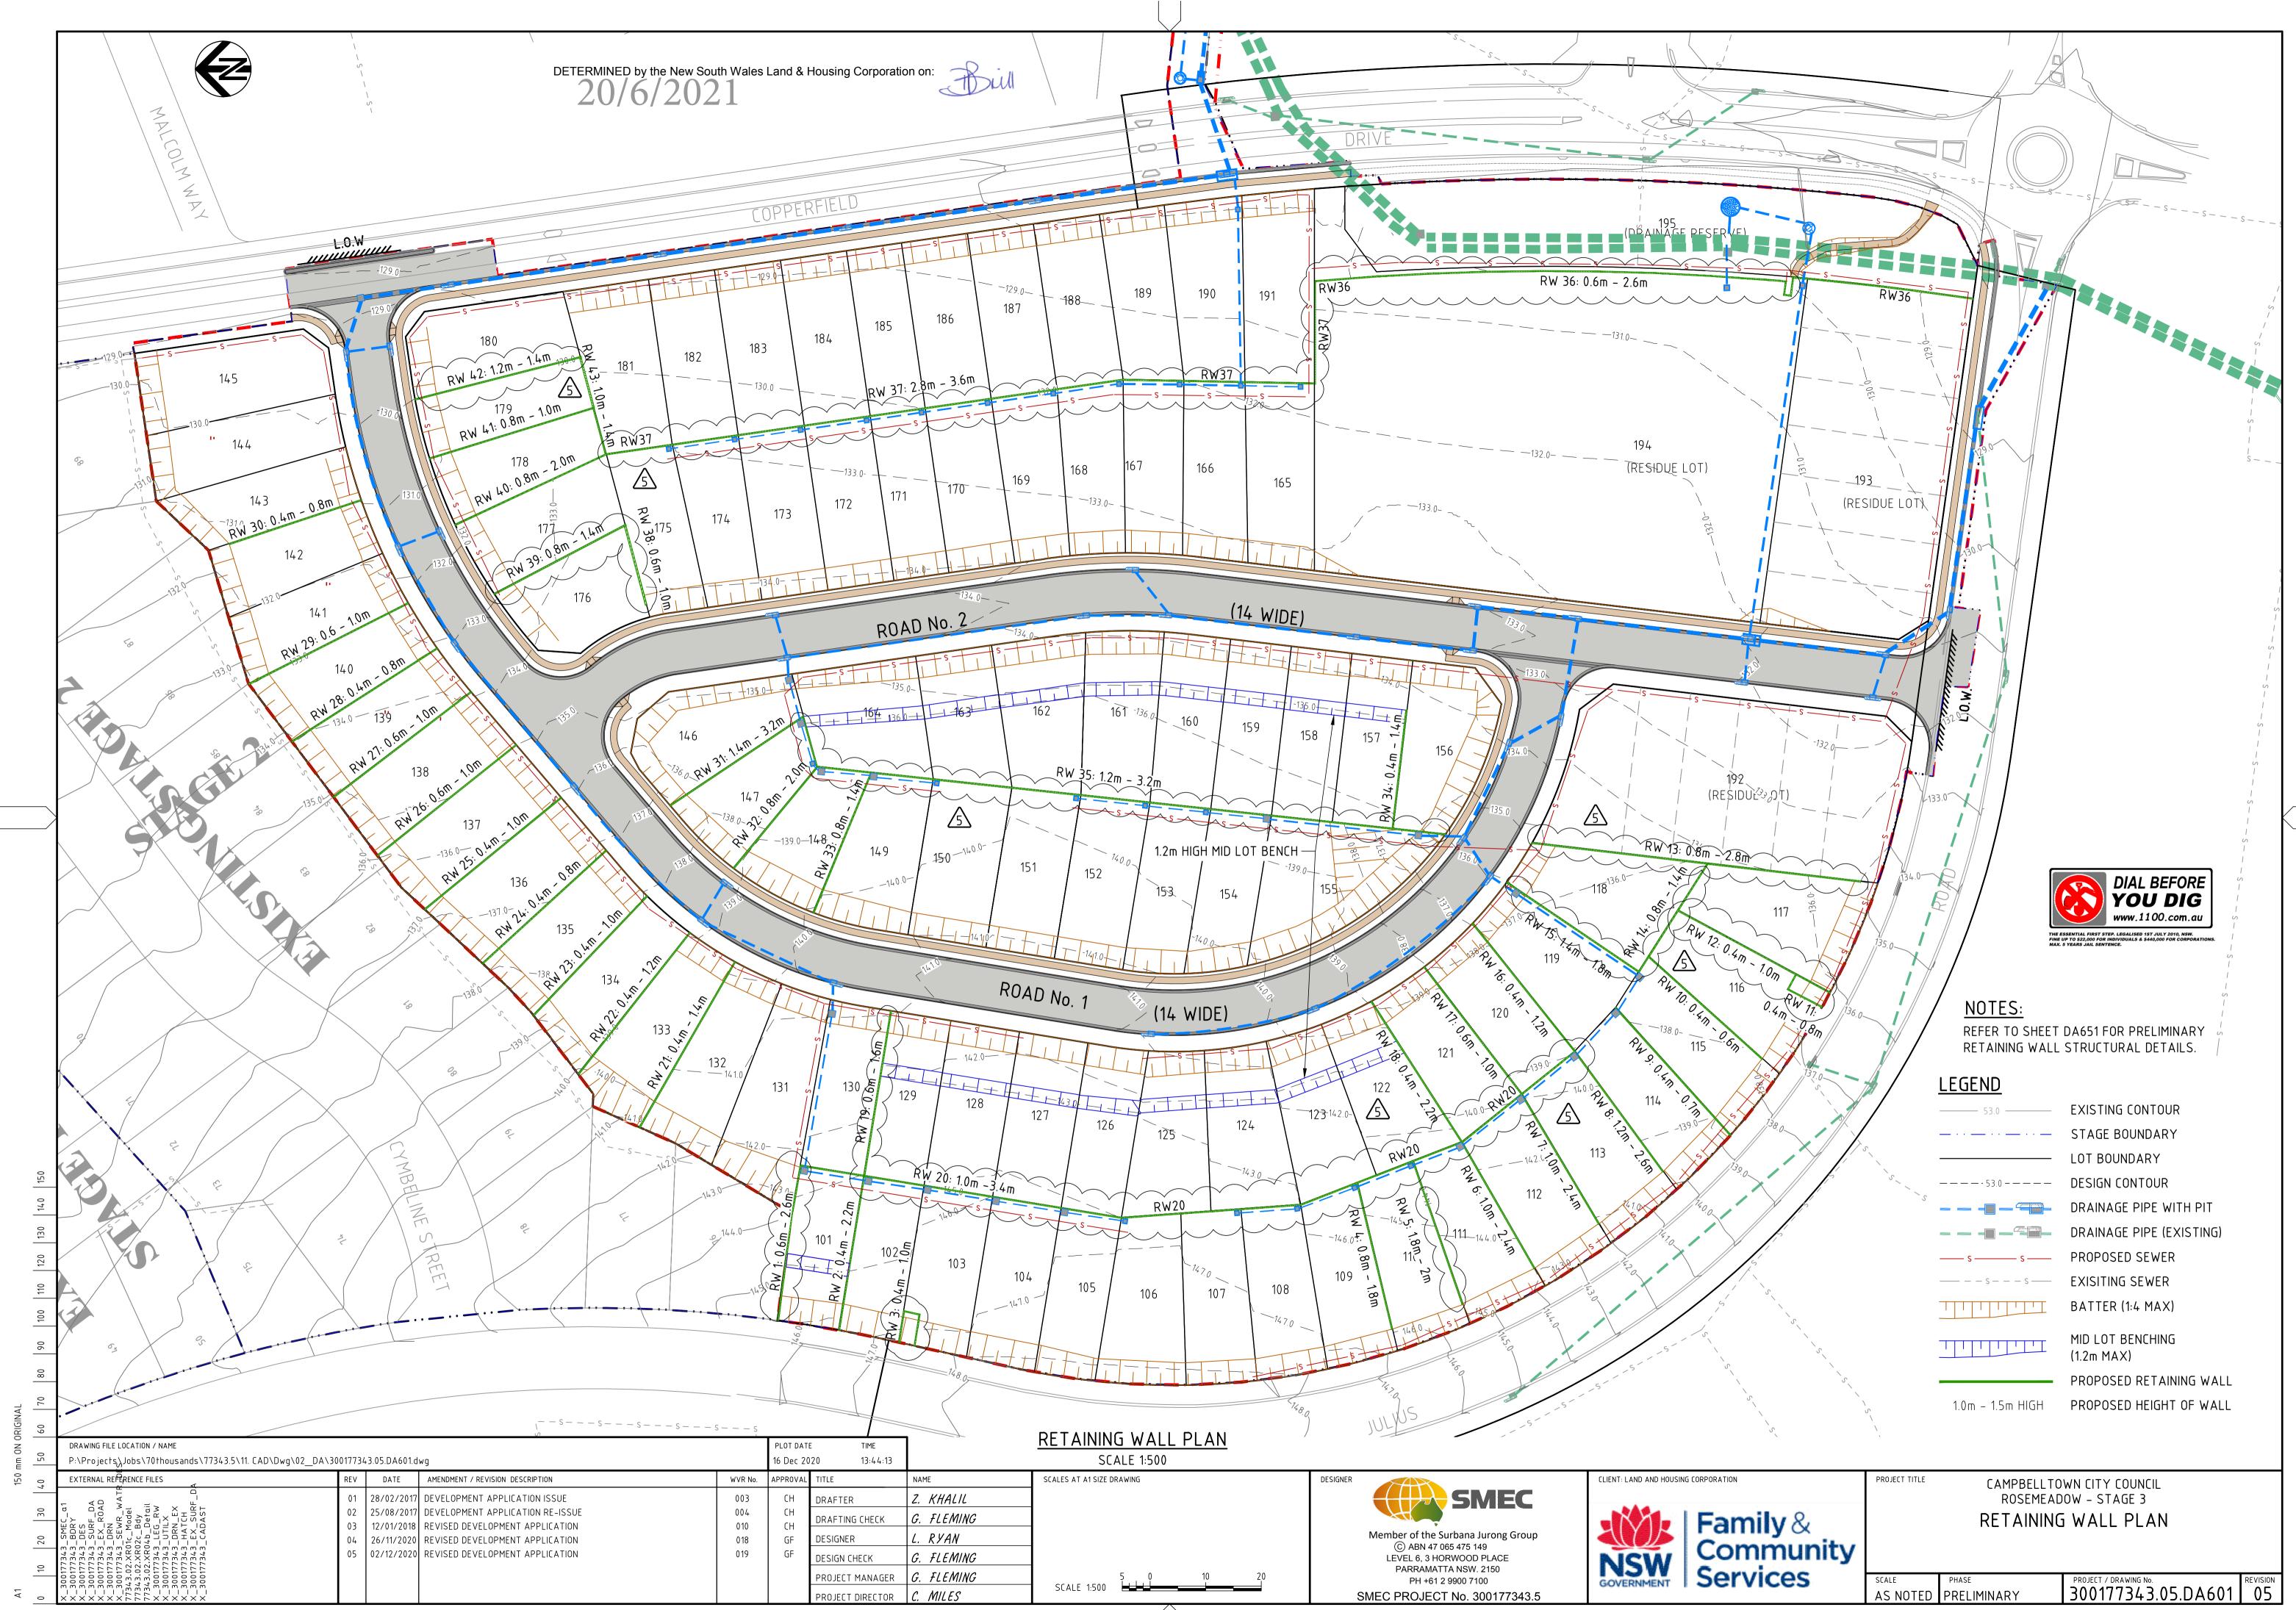


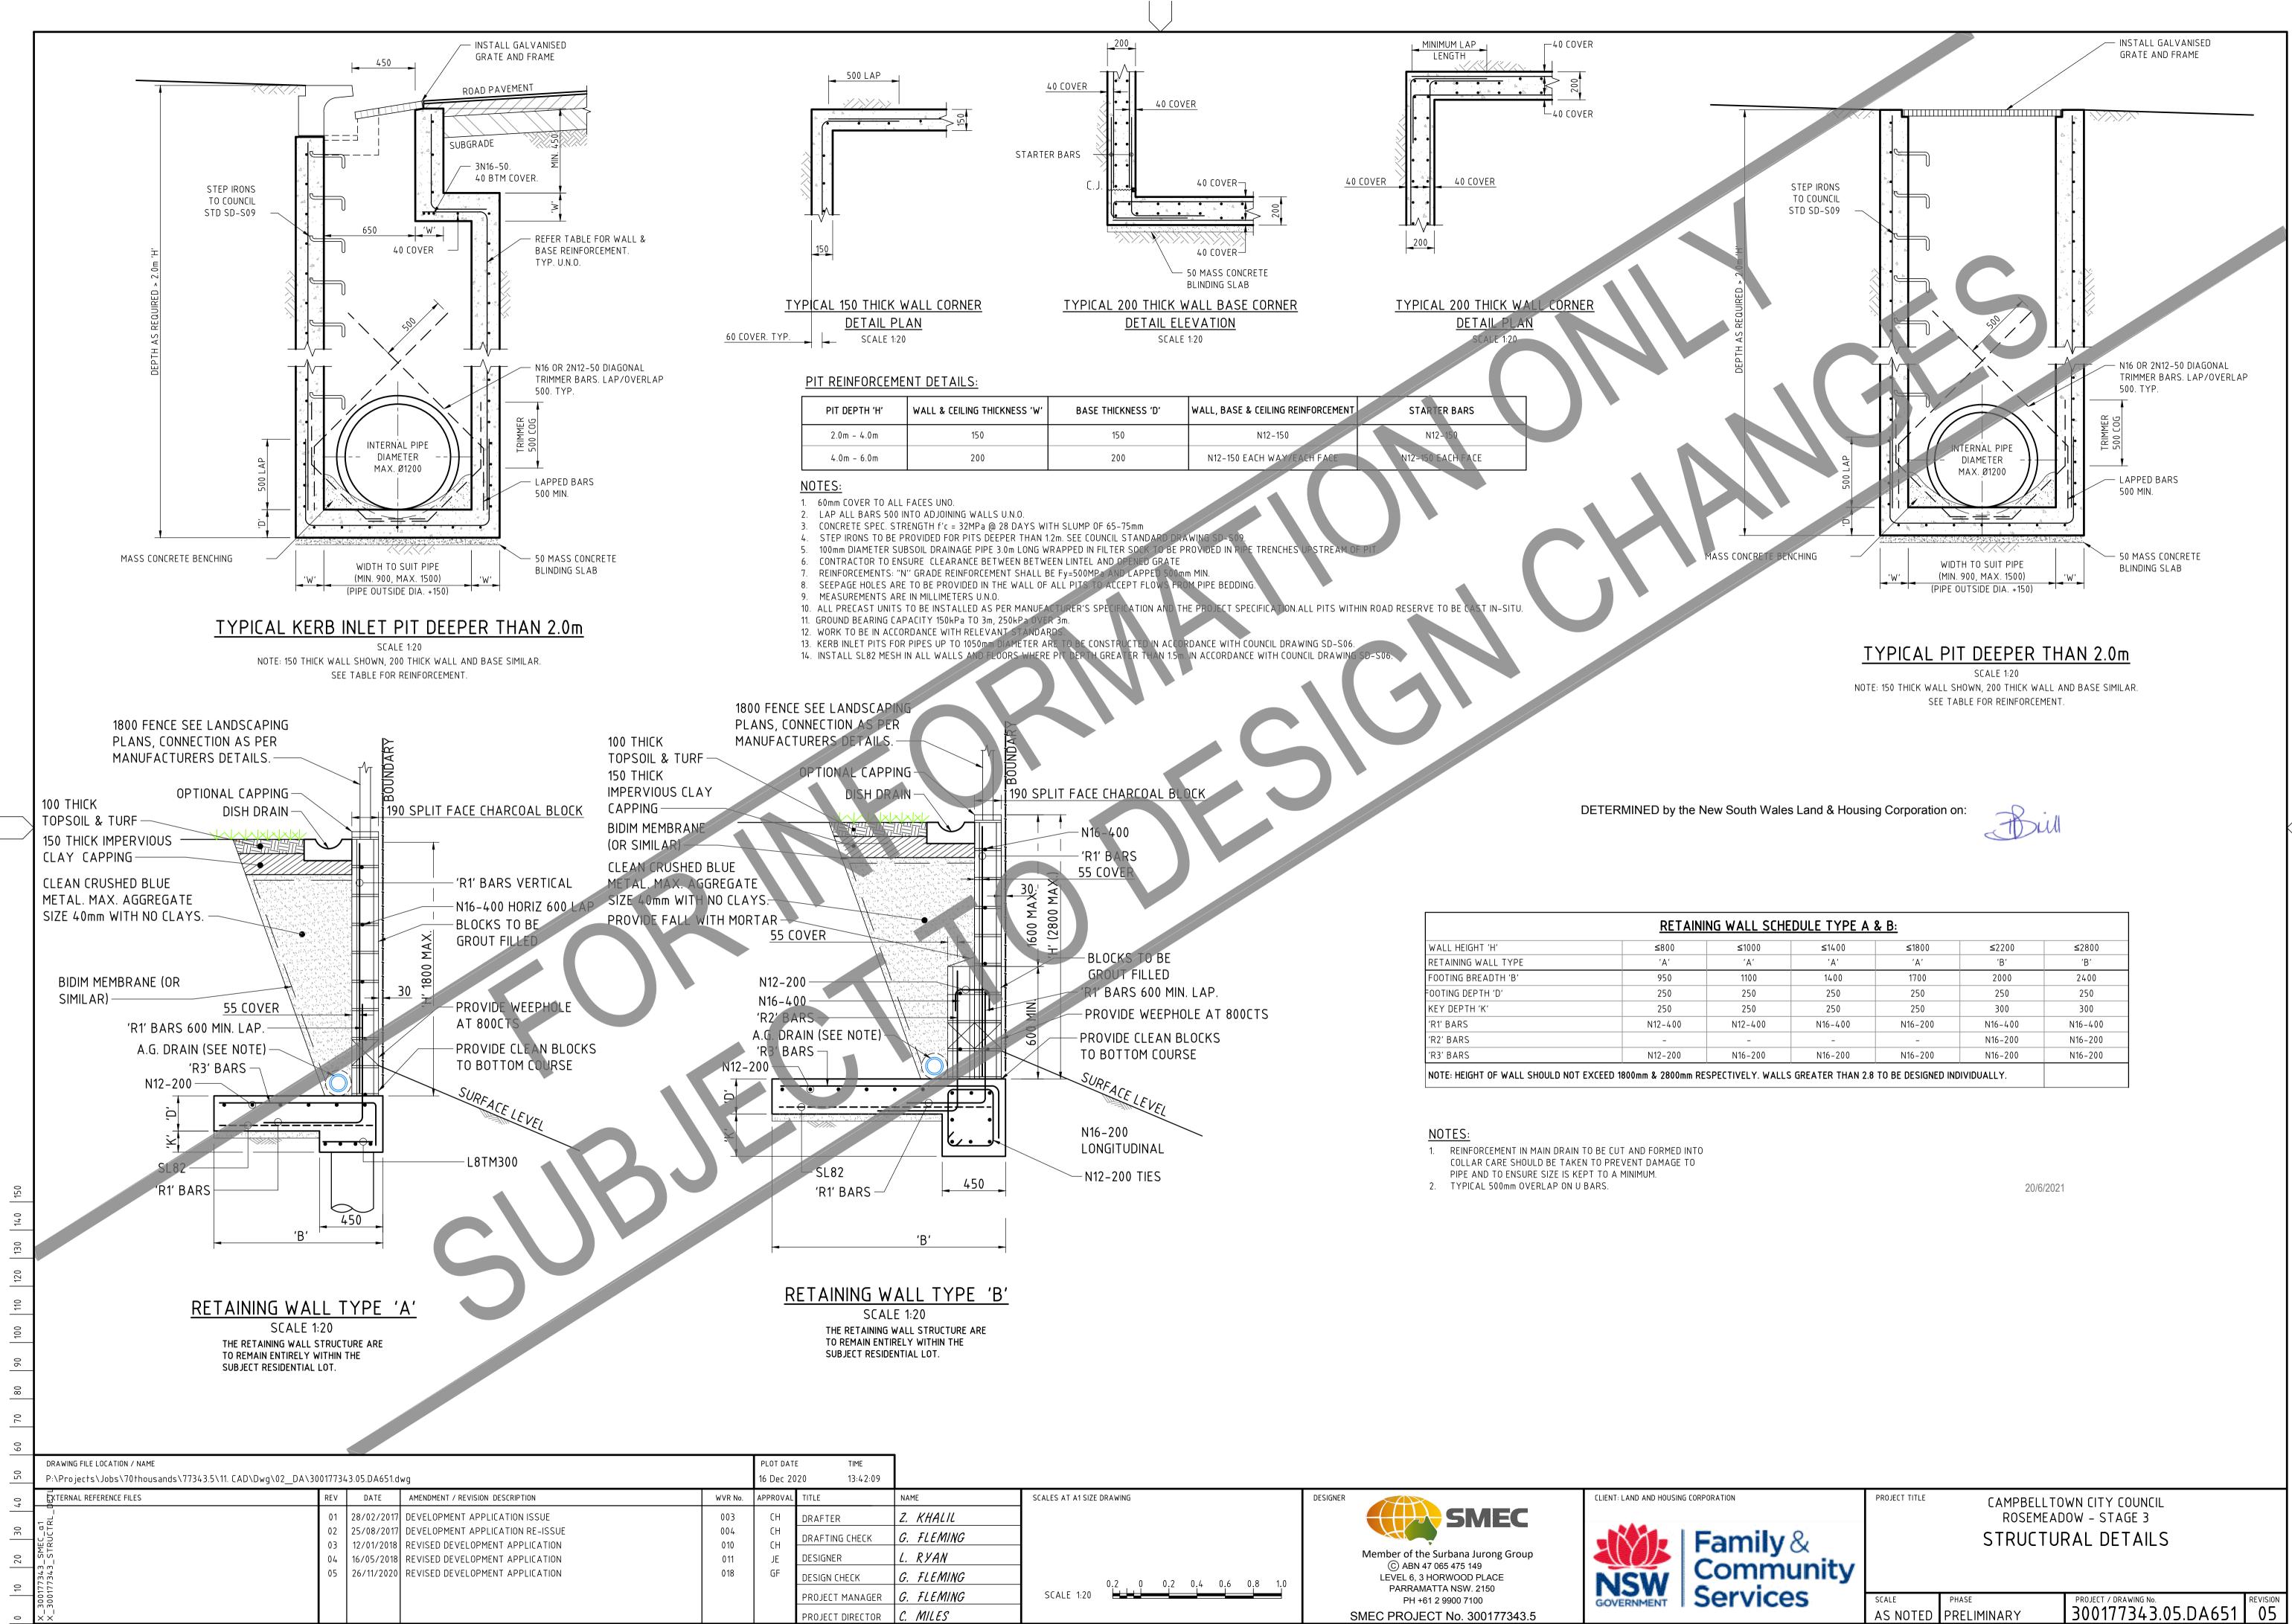


ANDSCAPING DETAILS. AL CAPPING DISH DRAIN	DE	TERMINED by the N	New So
П П П П П П П П П П П П П П		RETAINI	ING W/
	WALL HEIGHT 'H'	≤800	5
	RETAINING WALL TYPE	'A'	
GROUT FILLED	FOOTING BREADTH 'B'	950	
RI BARS 600 MIN. LAP.	FOOTING DEPTH 'D'	250	
PROVIDE WEEPHOLE AT 800CTS	KEY DEPTH 'K'	250	
	'R1' BARS	N12-400	N1
NOTE)	'R2' BARS	-	
TO BOTTOM COURSE	'R3' BARS	N12-200	N1
SURFAC	NOTE: HEIGHT OF WALL SHOULD NOT EXC	EED 1800mm & 2800mm RE	SPECTIV
SARS	NOTES: 1. REINFORCEMENT IN MAIN DRAIN TO I COLLAR CARE SHOULD BE TAKEN TO PIPE AND TO ENSURE SIZE IS KEPT 2. TYPICAL 500mm OVERLAP ON U BAI	O PREVENT DAMAGE TO TO A MINIMUM.	
'B'			


	_			
TIME 13:42:09				
	NAME	SCALES AT A1 SIZE DRAWING	DESIGNER	CLIENT: LAND AND HOUSING CORPORATION
	Z. KHALIL		SMEC	
G CHECK	G. FLEMING			- Far
2	L. RYAN		Member of the Surbana Jurong Group	
HECK	G. FLEMING	0.2 0 0.2 0.4 0.6 0.8 1.0	© ABN 47 065 475 149 LEVEL 6, 3 HORWOOD PLACE	NISW Con
MANAGER	G. FLEMING	SCALE 1:20	PARRAMATTA NSW. 2150 PH +61 2 9900 7100	GOVERNMENT Serv
DIRECTOR	C. MILES		SMEC PROJECT No. 300177343.5	

AS NOTED	PRELIMINARY	300177343.05.DA651	05
SCALE	PHASE	PROJECT / DRAWING No.	REVISIO

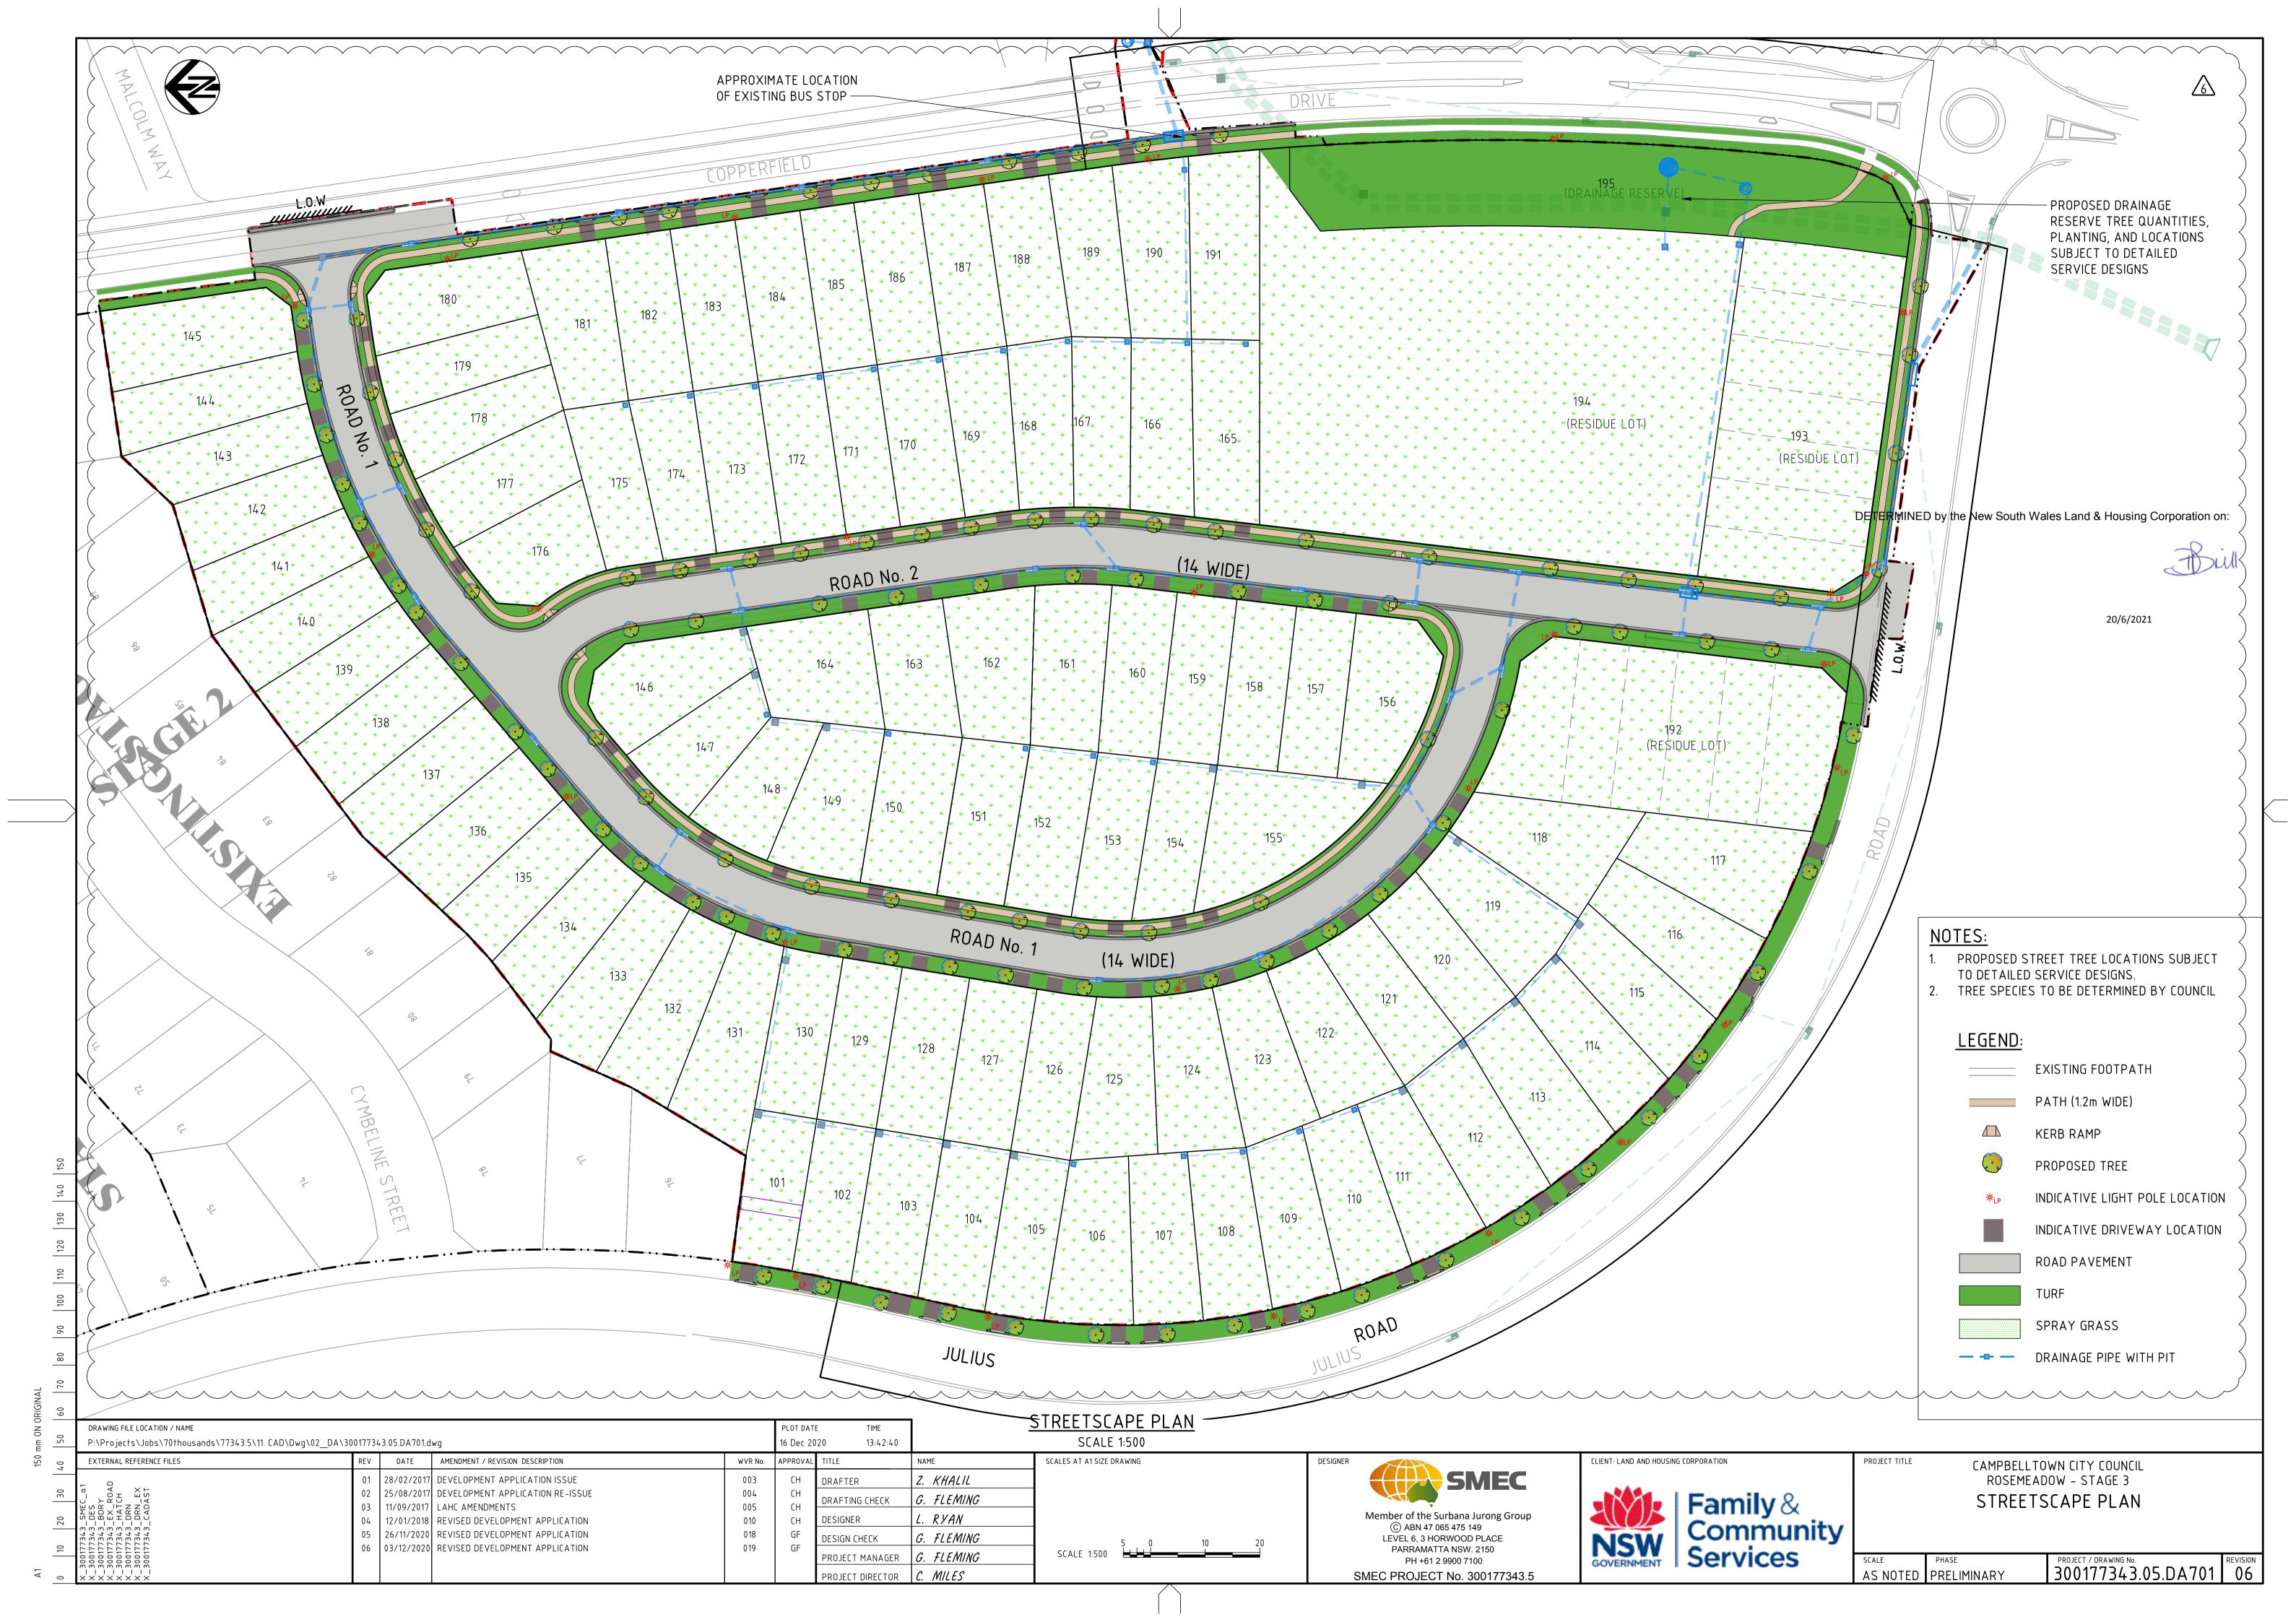


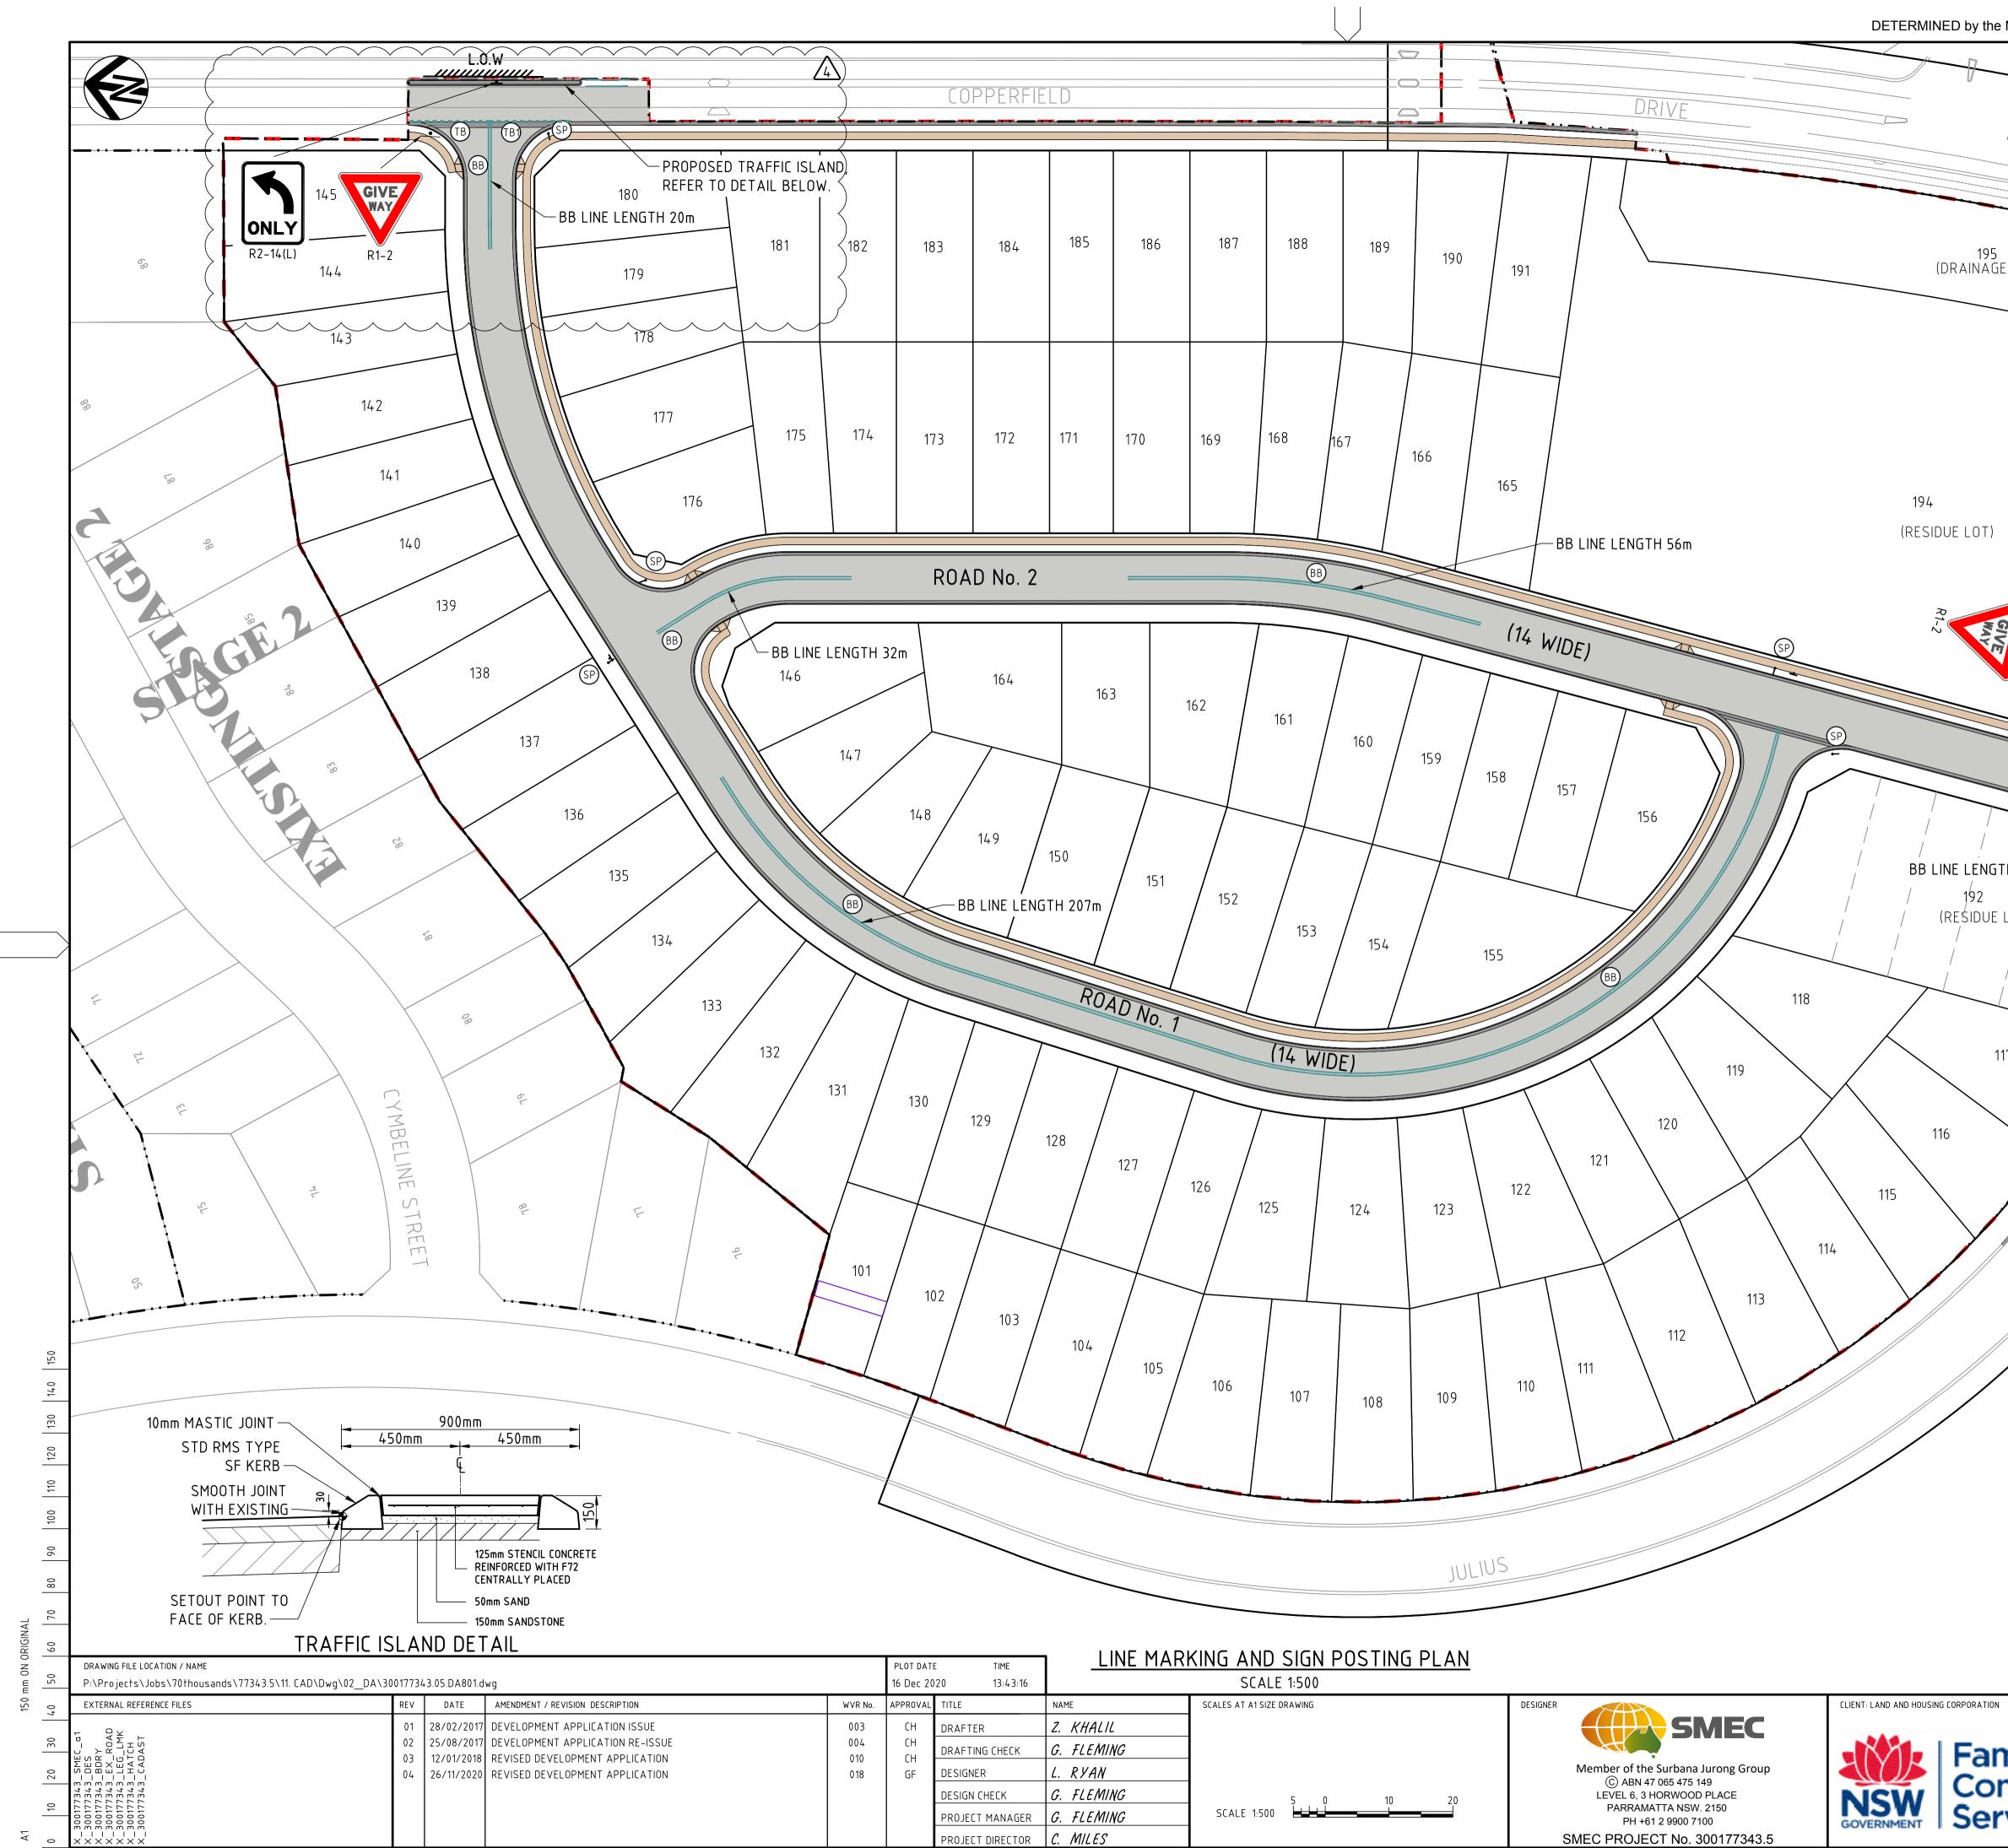


New South Wales Land	& Housing Co	prporation on:	Bill	
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			THE ESSENTIAL FIRST STEP. LEGALIS FINE UP TO \$22,000 FOR INDIVIDUALS MAX. 5 YEARS JAIL SENTENCE.	SED 1ST JULY 2010. NSW.
	040			
17	2	/		
		LINE MARKING:		
		HOLDING LINE		(TB)
		HOLDING LINE DOUBLE BARRIER LINI	F	(TB) (BB)
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			0- DIRECTIONAL WHIT	E
		REFLECTIVE UNLESS	NOTED OTHERWISE.	
		<u>SIGN POSTING:</u>	_	
		GIVE WAY		GIVE
		LEFT ONLY	ſ	RĨ-2
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		STREET SIGN	(9	
		NOTE:		
			IENT SCHEME SIGN POS	STING AND
		LINE MARKING TO E	BE IN ACCORDANCE TO ATION GUIDELINES ANI	R.M.S. (R.T.A.)
			NDARDS AS 1742.2-20	
		2. REFER TO TRAFFIC	REPORT REF 17002 PF LANNING FOR FURTHEF	
	PROJECT TITLE		WN CITY COUNCIL	
nily 9		ROSEMEAD	DOW - STAGE 3 D SIGN POSTING	
nily & mmunity				
vices	SCALE	PHASE	PROJECT / DRAWING No.	REVISION
		PRELIMINARY	300177343.05.[

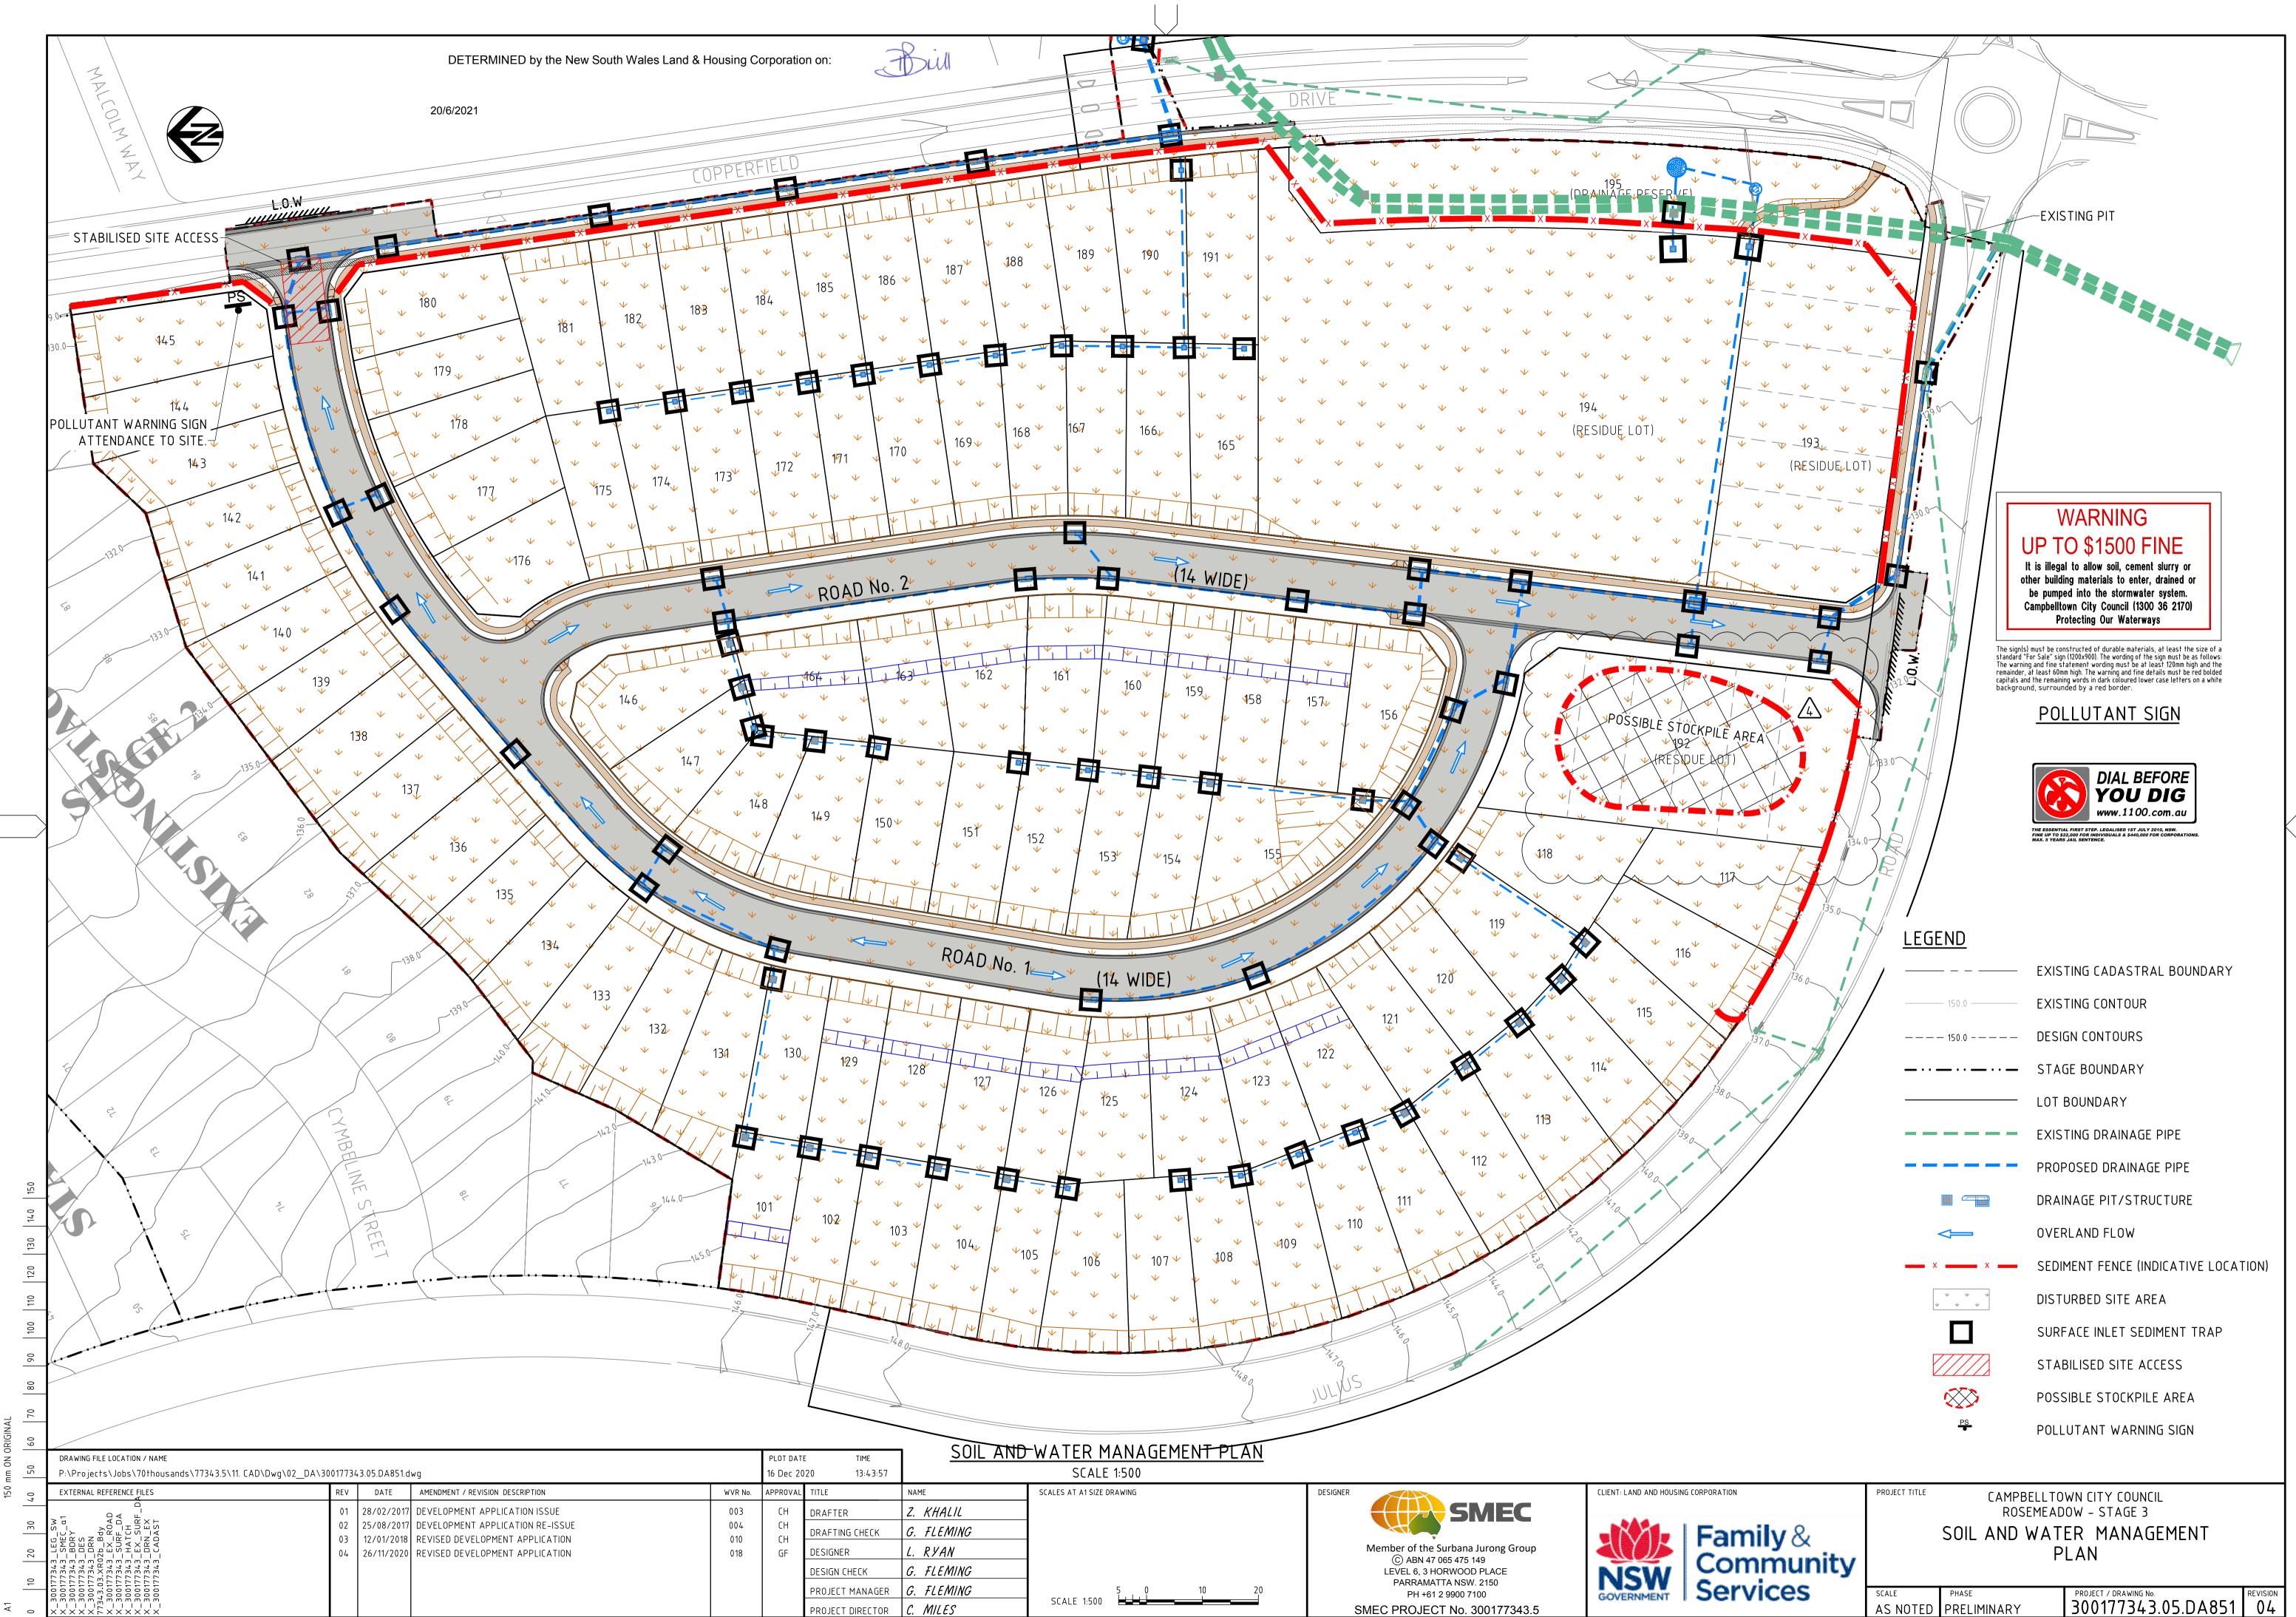

FTER	Z. KHALIL				SMEC	
FTING CHECK	G. FLEMING					
GNER	L. RYAN				Member of the Surbana Jurong Group ⓒ ABN 47 065 475 149	
GN CHECK	G. FLEMING				LEVEL 6, 3 HORWOOD PLACE	NICI
JECT MANAGER	G. FLEMING	5	0 10	20	PARRAMATTA NSW. 2150 PH +61 2 9900 7100	GOVERNM
IFCT DIRFCTOR	C. MILES	SCALE 1:500			SMEC PROJECT No. 300177343.5	

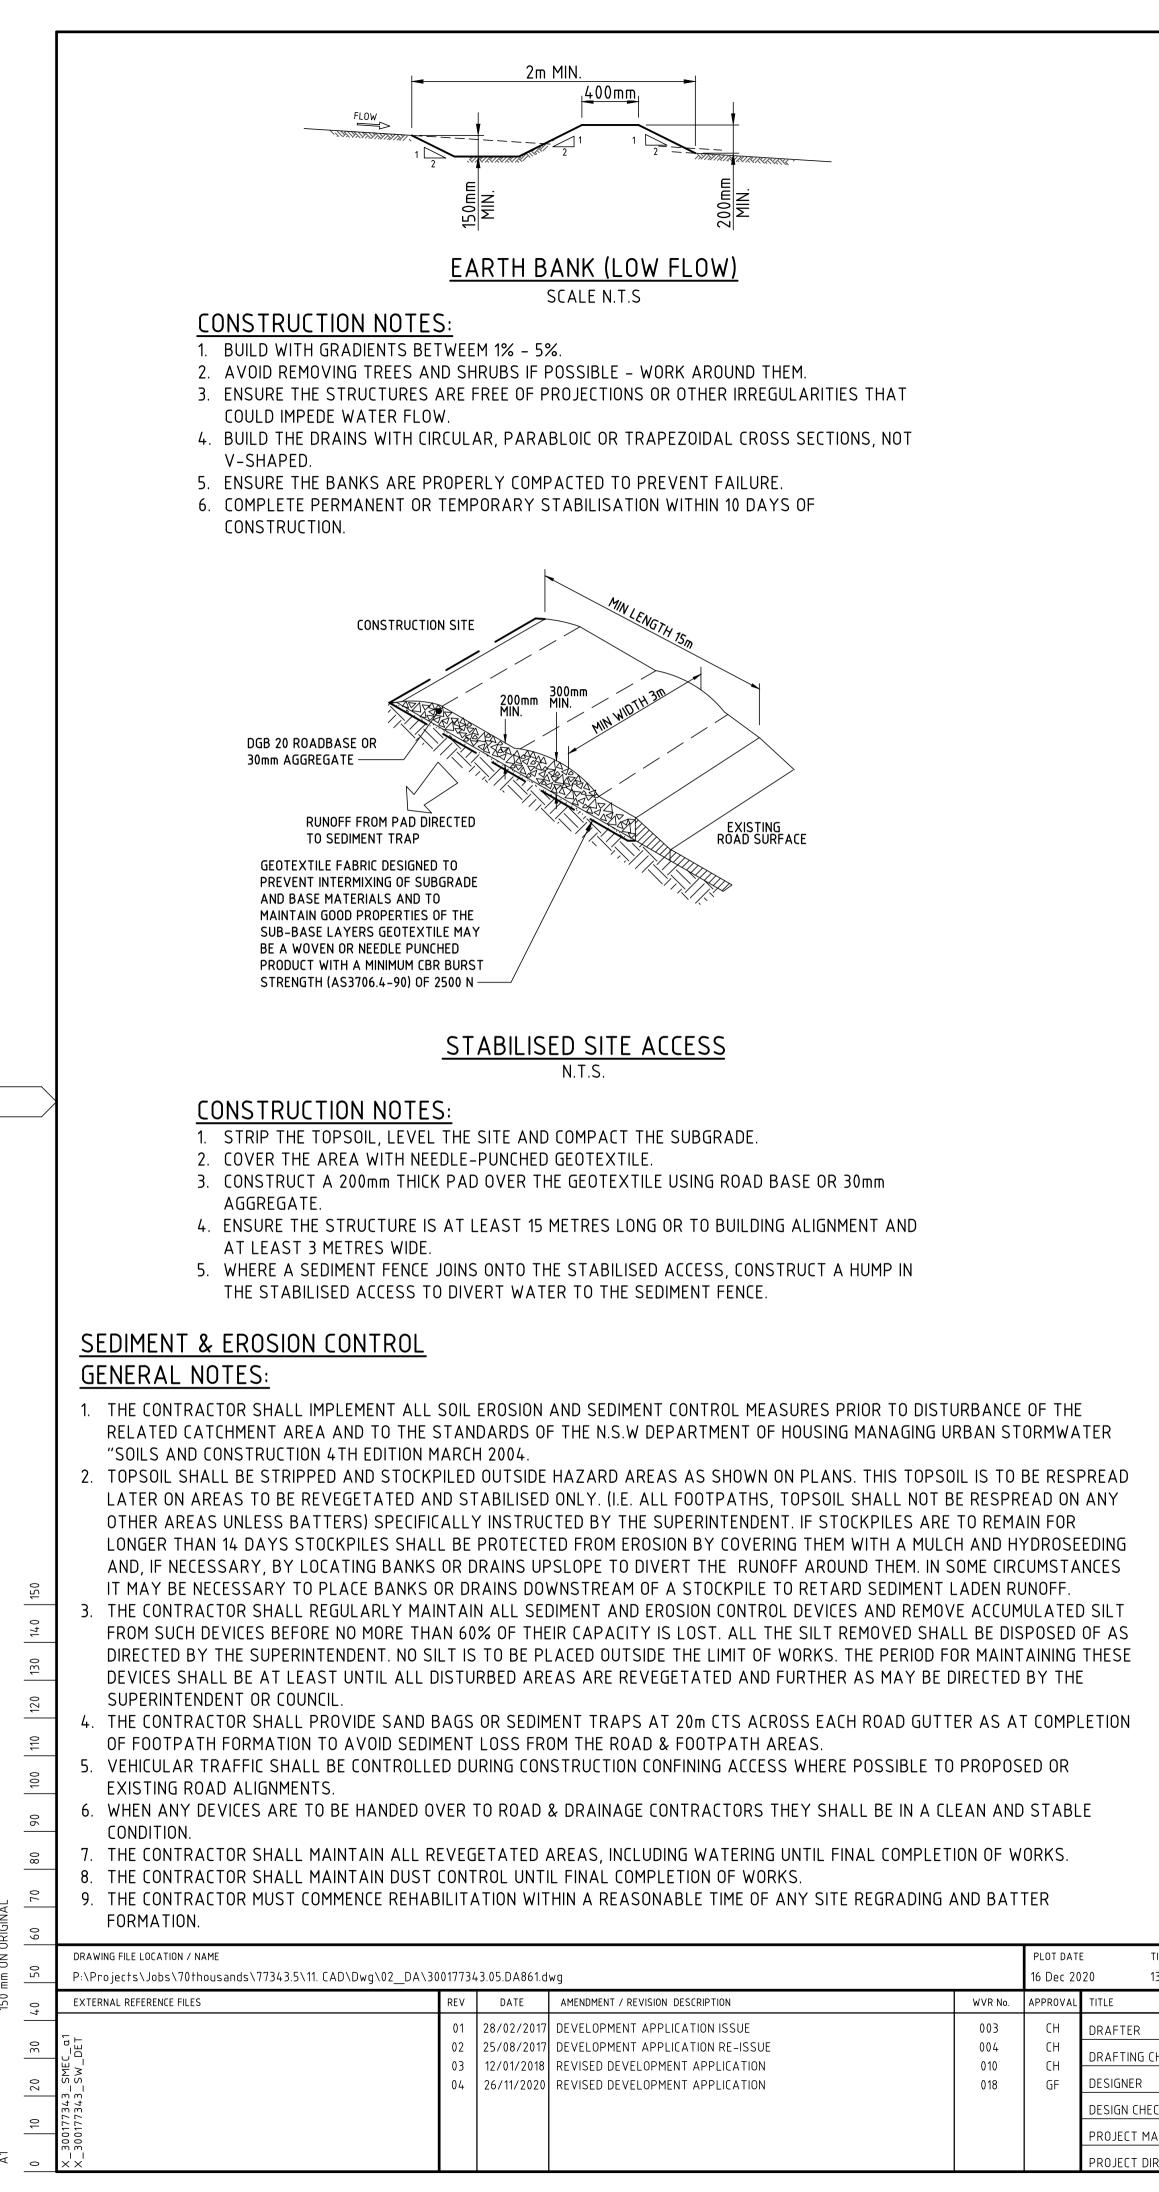

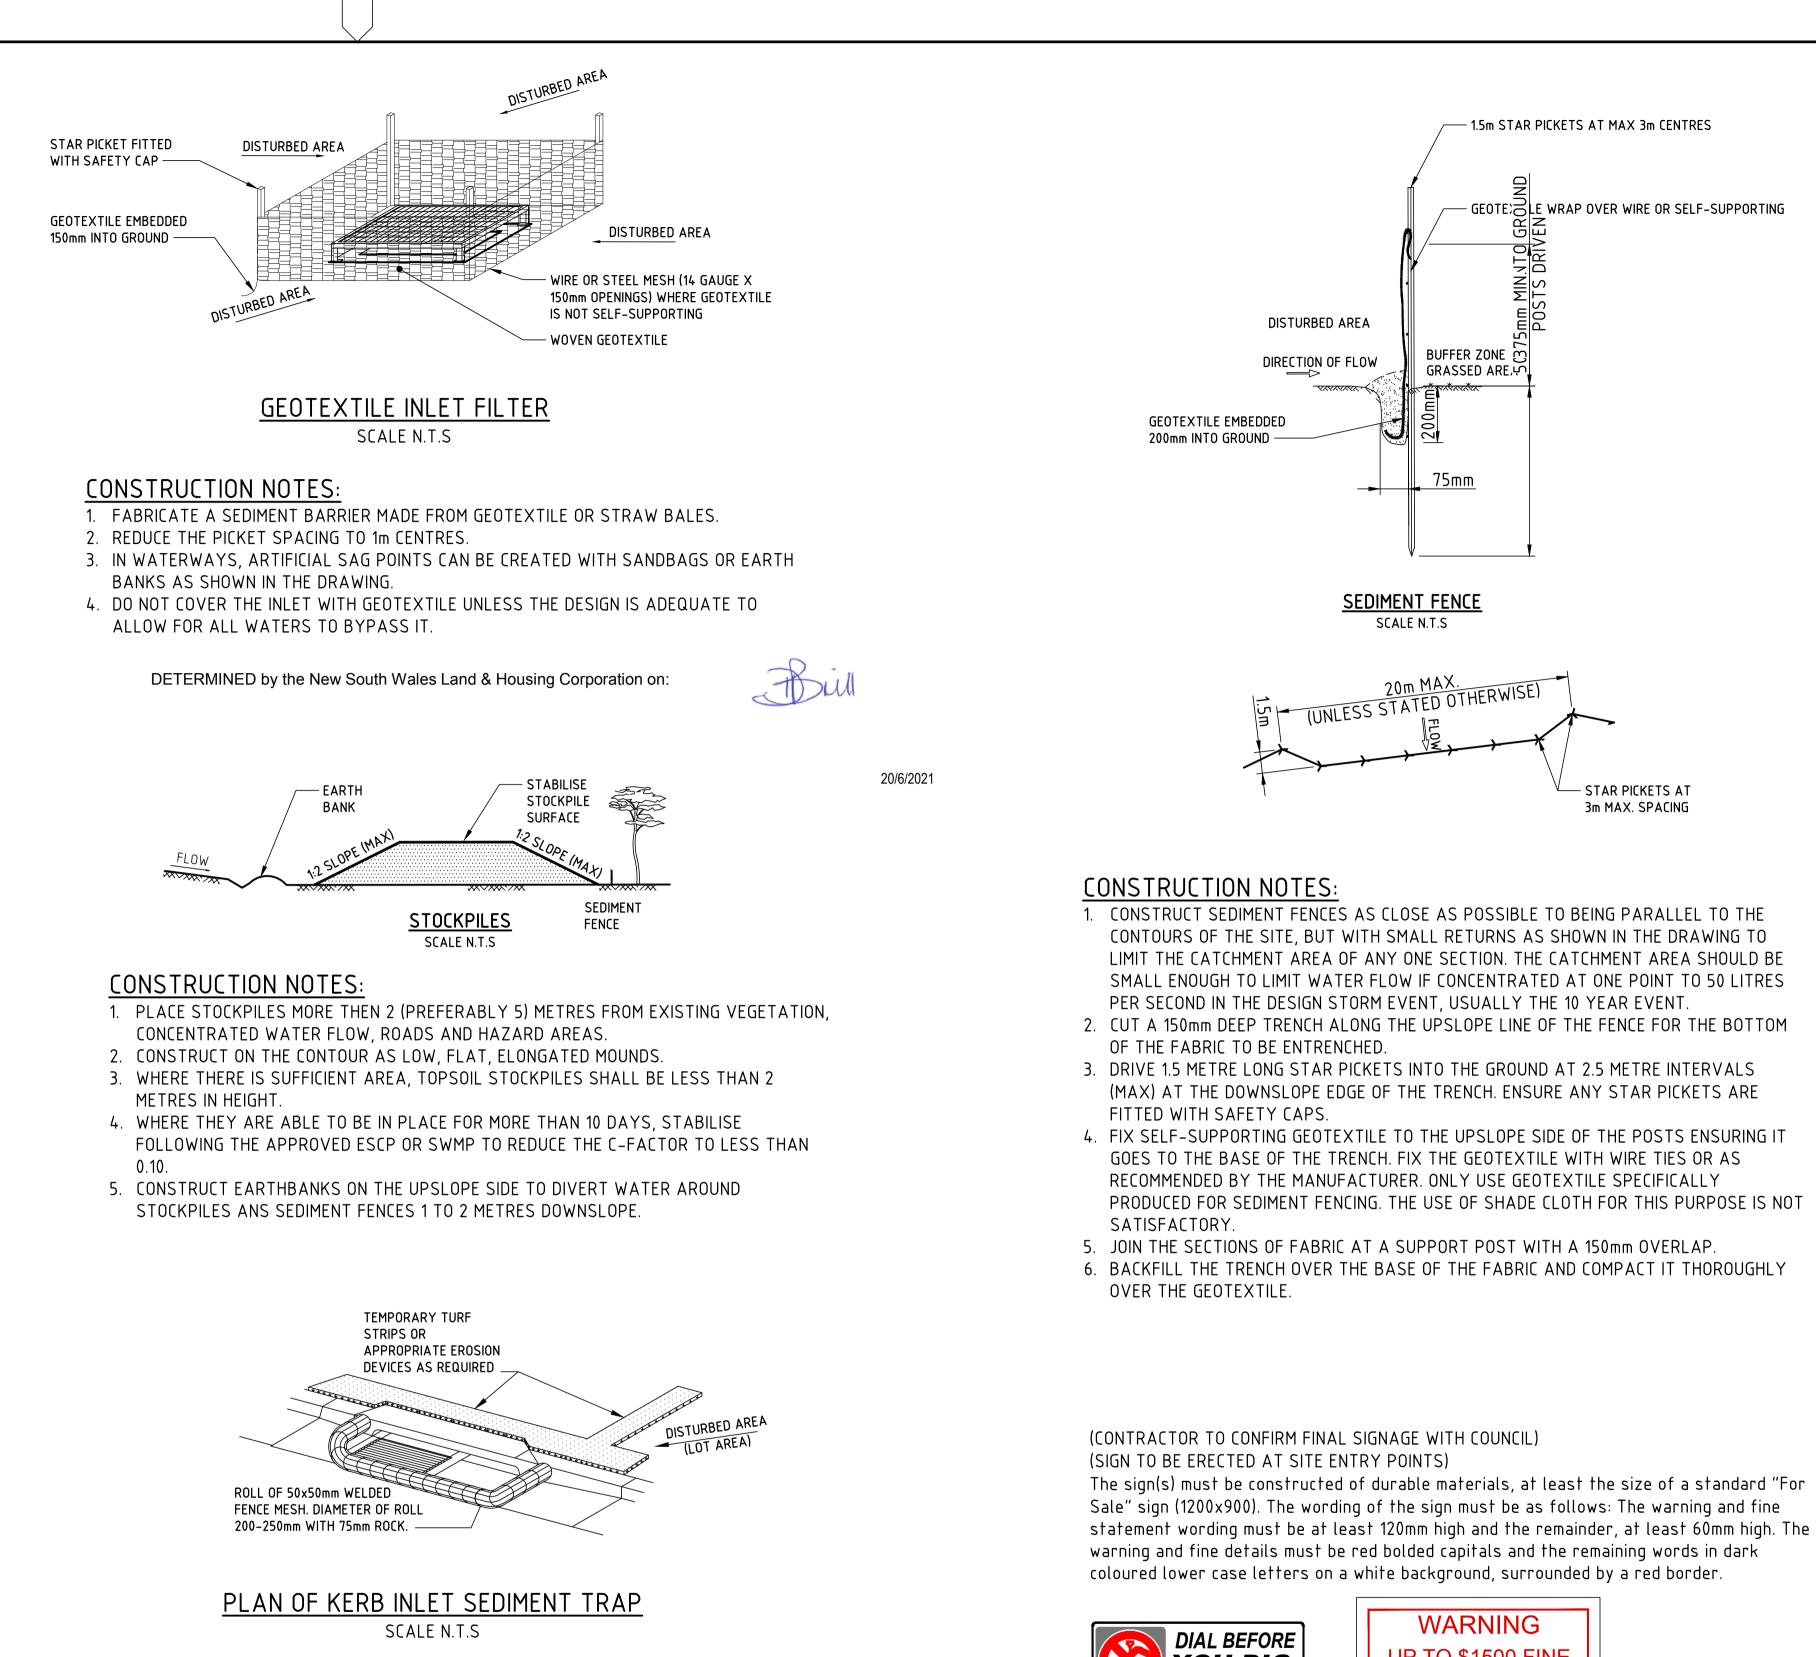


WASTE CONTROL:

- 1. THE CONTRACTOR TO BE RESPONSIBLE FOR WASTE DISPOSAL ON SITE.
- 2. ALL BUILDING PRODUCTS & CLEARED VEGETATION TO BE REMOVED OFF SITE IN AN APPROVED MANNER TO LICENSED LAND FILL SITE.
- 3. EQUIPMENT MAINTENANCE & REFUELLING OF CONSTRUCTION VEHICLES TO BE DONE IN A DESIGNATED AREA USING BUNDING AND BEST PRACTICE MANAGEMENT CONTROLS FOR REFUELLING.
- 4. ALL SPILLS TO BE CLEARED UP IMMEDIATELY.

IME								
3:44:22								
	NAME	SCALES AT A1 SIZE DRAWING	DESIGNER	CLIENT: LAND AND HOUSING CORPORATION	PROJECT TITLE	CAMPBELLTO	WN CITY COUNCIL	
	Z. KHALIL		SMEC				DOW – STAGE 3	
НЕСК	G. FLEMING			Family &		SOIL AND WAT	ER MANAGEMENT	
	L. RYAN		Member of the Surbana Jurong Group ⓒ ABN 47 065 475 149 LEVEL 6, 3 HORWOOD PLACE					
CK	G. FLEMING			NSW Community				
NAGER	G. FLEMING		PARRAMATTA NSW. 2150 PH +61 2 9900 7100	GOVERNMENT Services	SCALE	PHASE	PROJECT / DRAWING No.	REVISION
RECTOR	C. MILES		SMEC PROJECT No. 300177343.5		AS NOTED	PRELIMINARY	<u>300177343.05.DA861</u>	04



WARNING			
UP TO \$1500 FINE			
It is illegal to allow soil, cement slurry or other building materials to enter, drained or be pumped into the stormwater system. Campbelltown City Council (02 4645 4000) Protecting Our Waterways			

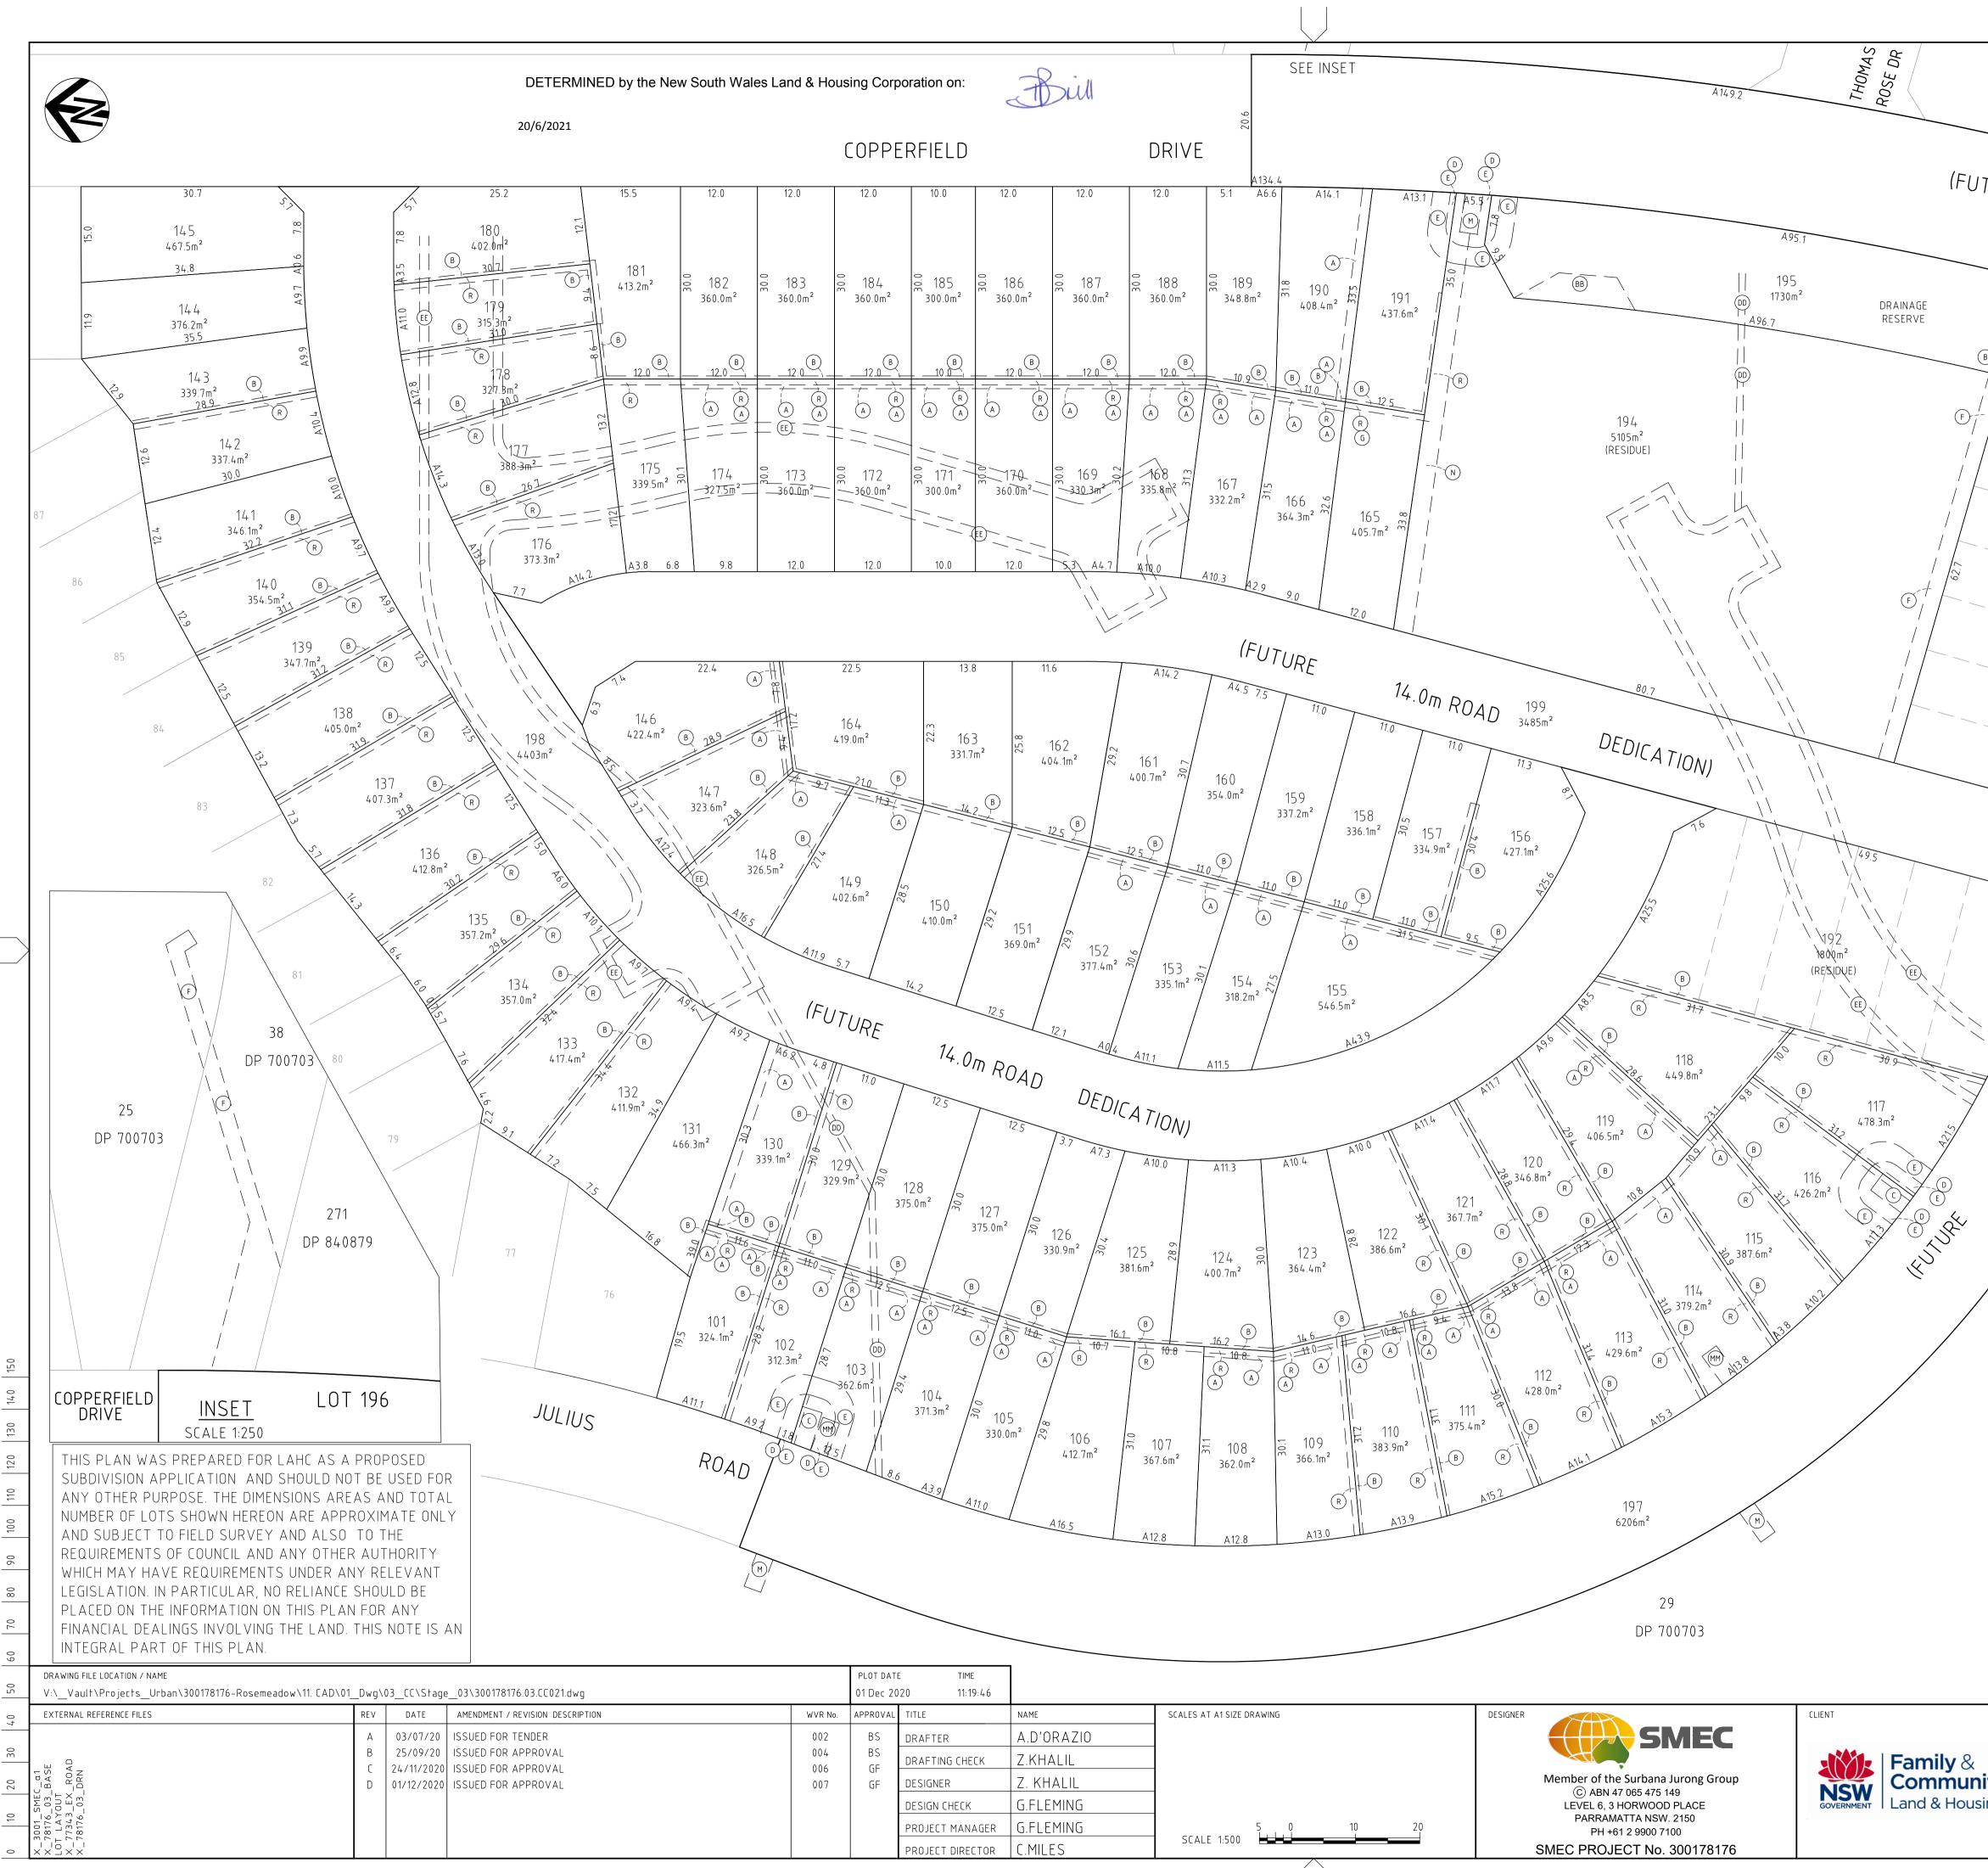

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		DRAINAGE RESER		
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DEDICA TION	PROPERTY IN	FORMATION		
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D _l		PART	VOLUME 3714 FOLIO 16 N DP 1166578)	
		CREATI	ION OF EASEMENT TO DR R OVER LOTS 25 & 38	RAIN
	/ <u>LEGEND</u>	DP7007	103	
ROAD 18 WIDE	PROPO	SED LOTS		
24 81 18 14		NG CADASTRAL B	OUNDARY	
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		BELLTOWN CITY C		
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nity Services				
ising Corporation	SCALE PHASE	PROJECT / DR.		VISION
	AS NOTED APPROVAL	300178	3176.03.CC021 [)